REGULAR MEETING OF THE ZONING ADMINISTRATOR OF THE CITY OF VICTORVILLE

DECEMBER 16,2020 10:00AM **ZOOM INFORMATION**

MEETING LINK: https://vv.city/2JAWlt8

MEETING ID: 918 0460 2601

PASSCODE: V V123

Call IN NUMBER: (669) 900 9128

Notice to the Public: This meeting is being held in accordance with the Brown Act that is currently in effect under the State Emergency Services Act, the Governor's Emergency Declaration related to COVID-19, and the Governor's Executive Order N-29-20 issued on March 17, 2020. To minimize the spread of COVID-19, City Conference Rooms are closed to the public. This meeting will be available via Zoom and can be accessed through the following link: https://vv.city/2JAWIt8 or by phone (669) 900 9128. **Meeting ID: 918 0460 2601 and Passcode V V123**

To provide public comments during Zoom, click "Raise Hand" and you will be advised to speak and be unmuted. If you would like your comments to be read during the meeting, please email planning@victorvilleca.gov no later than December 15, at 3:00 p.m. Include the agenda item number in your subject line; if your comment doesn't pertain to an item, indicate "general public comment" in the subject line.

ANY INDIVIDUAL WITH A DISABILITY WHO REQUIRES REASONABLE ACCOMMODATIONS TO PARTICIPATE IN A ZONING ADMINISTRATOR'S MEETING MAY REQUEST ASSISTANCE AND/OR RECEIVE THE AGENDA IN AN ALTERNATIVE FORMAT BY CONTACTING THE DEVELOPMENT DEPARTMENT SECRETARY AT (760) 955-5135 NO LATER THAN SEVENTY-TWO HOURS PRIOR TO THE MEETING

CALL TO ORDER

PUBLIC HEARING

1. MINOR INTERIM USE PERMIT ADMN20-00096- Urbanest Group, Inc.

ENVIRONMENTAL - CONSIDERATION OF AN ENVIRONMENTAL EXEMPTION

PROJECT - A MINOR INTERIM USE PERMIT WITH AN ENVIRONMENTAL EXEMPTION TO ALLOW FOR THE ESTABLISHMENT OF A PARCEL DELIVERY SERVICE WITHIN AN EXISTING COMMERCIAL BUILDING AND A MINOR SITE PLAN TO ALLOW FOR ASSOCIATED SITE IMPROVEMENTS TO TAKE PLACE ON A C-2 ZONED PROPERTY

LOCATION- 15272 BEAR VALLEY ROAD

<u>ATTACHMENT-</u> A. SITEPLAN

B. PROJECT DESCRIPTION

C. TRAFFIC ANALYSIS

D. AGENCY COMMENTS

E. AERIAL IMAGE

*Revised condition as of 12/16/2020 at 9:30am

PUBLIC COMMENTS

ADJOURNMENT

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ZONING ADMINISTRATOR STAFF REPORT

DATE: DECEMBER 16, 2020 AGENDA NO. 1

CASE: ADMN20-00096

SUBJECT: A MINOR INTERIM USE PERMIT WITH AN ENVIRONMENTAL EXEMPTION TO

ALLOW FOR THE ESTABLISHMENT OF A PARCEL DELIVERY SERVICE WITHIN AN EXISTING COMMERCIAL BUILDING AND A MINOR SITE PLAN TO ALLOW FOR ASSOCIATED SITE IMPROVEMENTS TO TAKE PLACE ON A C-2

ZONED PROPERTY

APPLICANT: URBANEST GROUP, INC.

LOCATION: 15272 BEAR VALLEY ROAD

I. STAFF RECOMMENDATION:

Staff recommends that the Zoning Administrator conduct a public hearing, receive testimony regarding the proposed project and take the following actions:

- 1. Environmental Assessment Find the project categorically exempt per CEQA as follows:
 - a) Minor Site Plan Exempt pursuant to Section 15301(a)(c) & (d) titled "Existing Facilities", Section 15303(d) & (e) titled "New Construction and Conversion of Small Structures", and Section 15311 titled "Accessory Structures";
 - b) Minor Interim Use Permit Exempt pursuant to Section 15301(a)(c) & (d) titled "Existing Facilities"; and
- 2. Minor Site Plan Approve the Minor Site Plan portion of case ADMN20-00096, subject to the recommended conditions by finding that the proposal is in accordance with Section 16-3.01.030 of the Development Code and meets the applicable requirements of Title 16; and
- 3. Minor Interim Use Permit Approve the Minor Interim Use Permit portion of case ADMN20-00096 subject to the recommended conditions by finding that the proposal meets the requirements of the City Council Policy for Interim Uses (CP-11-05), including basis of need and required findings as outlined within the Staff Analysis section of the Zoning Administrator Staff Report.

II. <u>SUMMARY</u>:

The applicant is requesting approval of this Minor Site Plan and Minor Interim Use Permit in order to allow for the establishment of a parcel delivery service and accessory office/customer service area within an existing approximately 126,000 sq. ft. vacant commercial building in a C-2 (General Commercial) Zone District. The proposal on the approximately 21.5 acre building site includes the reuse of the existing building and parking field on the southern 12.5 acres of the site as well the rehabilitation of the northern 9 acres of the site that includes the conversion of a drive-in movie theater parking field to a screened parking field for delivery vehicles. Included in the proposal are associated architectural changes to the building elevations such as a small storefront and new staging canopy, as well as site updates to the overall site including new landscaping, walls/fencing, refuse collections areas, revised on-site circulation, and street improvements. These associated

improvements will bring the site into conformance with current Municipal Code standards, improve the quality of the site, and reduce any potential negative impacts to the surrounding commercial development as well as the residences to the east.

III. STAFF ANALYSIS:

1. Environmental Assessment.

The California Environmental Quality Act (CEQA) provides a list of projects which have been determined not to have a significant effect on the environment and are exempt from the provisions of CEQA. These "Categorical Exemptions" are applicable to certain projects and exempt a land use proposal from CEQA provided they are found not to have a significant effect on the environment. Therefore, based upon the various Categorical Exemptions provided by CEQA, Staff finds that the following are applicable to the subject proposal:

Existing Facilities (Applicable to Minor Site Plan & Minor Interim Use Permit)

• Section 15301(a)(c) & (d) of CEQA allows for projects at existing facilities whose permitting, licensing, and minor alterations involve negligible or no expansion of the sites existing use, including alterations such as: interior/exterior alterations to interior partitions, plumbing, and electrical conveyances; alterations to existing roadways; and restoration or rehabilitation to deteriorated structures and facilities. Due to the fact that the entire site was previously developed with areas falling into disrepair to due vacancy and deterioration, and because the activities and improvements proposed on-site will update and restore the site and surrounding roadways in a manner consistent with current design standards that do not increase the traffic, noise, or other adverse impacts to the vicinity previously generated by the projects historical use as a 24-hour retail site and drive-in movie theater; Staff finds this exemption from CEQA applicable.

New Construction or Conversion of Small Structures (Applicable to Minor Site Plan)

Section 15303(d) & (e) of CEQA allows for the construction and location of small facilities
and structures, including the conversion from one use to another where only minor
modifications are made in the exterior of the structure. Inasmuch as the proposed
construction activities on-site include the improvement of an existing roadway (Balsam
Road) as well as accessory structures like parking lot improvements, landscaping,
fences/walls, refuse collection areas, covered parking/staging canopy, and interior/exterior
adjustments to an existing structure, Staff finds this CEQA exemption applicable.

Accessory Structures (Applicable to Minor Site Plan)

 Section 15311(b) of CEQA allows for the construction of minor structures accessory to (appurtenant to) existing commercial facilities. Therefore, Staff finds that the conversion of the existing drive-in movie theater parking area to a parking lot as well as site improvements such as landscaping, refuse collection areas, and fences/walls are considered appurtenant to the existing commercial building and are therefore exempt from CEQA.

2. Minor Site Plan.

General Information

• The existing approximately 21.5 acre site was previously developed and has been utilized for two separate businesses, a Walmart operated 24-hours a day and was located on the

southern 12.5 acres of the project site and a drive-in movie theater was located on the northern 9 acres of the project site. Although the entire site is improved, the northern half lacks landscaping and street improvements while the southern half of the site includes full site improvements that have deteriorated (e.g. dead/dying landscaping and weathered parking field) due to vacancy of the subject site.

• In order to address existing site conditions, modify the site design to accommodate the proposed parcel delivery operation, as well as update and improve the location in a manner consistent with Victorville Municipal Code (V.M.C.) requirements, the applicant has proposed the following:

Building Changes

O Updates to the interior and exterior of the existing commercial building to accommodate delivery, sorting, and administrative functions of the proposed business. Exterior changes include the addition of roll-up bay doors on the north and west elevations (located to limit visibility from the right-of-way), a new canopy at the north elevation to accommodate vehicle loading and staging, as well as a new entrance façade for the proposed tenant that will be utilized for employee entrance/exit and as a customer service area for pick-up and return of items by patrons. Staff finds that the elevation changes are: appropriate given the proposed change in use; in accordance with the Commercial Design Guidelines given the bay doors orientation away from neighboring properties; and an improvement of the existing design given the limitation of working within the shell of the existing structure. Staff has included Conditions 2, 5 & 20-22 in order to ensure the architectural design remains in accordance with the Commercial Design Guidelines and the V.M.C., which will address items such as the interior location of scupper/roof drains, screened utility and rooftop equipment, and verification of the final colors and materials to be used.

Parking Field

Parking fields throughout the site will include a redesigned circulation pattern in order to accommodate customer and employee parking as well as delivery vehicle parking/staging areas that are restricted to delivery vehicle access only. In order to ensure the entire parking is updated in accordance with V.M.C. standards and deteriorated parking areas are improved, Staff has included Condition 10, requiring the slurry coat and seal, as well as restriping of all areas of the project site.

Landscaping

- New and replaced landscaping is included along right-of-way frontages including Balsam Road and the future Huerta Road. Perimeter landscaping is designed as dual use and will function as bioretention basin with landscaping consisting of 24" – 36" box trees as well as other drought tolerant landscaping and ground cover. In order to ensure all existing and proposed landscaping is maintained, Staff has included Condition 18 requiring the permanent maintenance of all landscaped areas on-site.
- The parking field at the south half of the site where areas for customer, employee and some delivery van parking are provided will be improved to include interior landscaping and planters throughout. Areas designated as restricted access for delivery vehicles will be screened from public view (as discussed separately in this analysis) and include limited landscape improvements as they are not required parking. Staff has included Conditions 15 & 16 in order to ensure all required landscaping installed at the perimeter

of the site and within parking areas complies with the applicable requirements of the V.M.C., including planter size, plant spacing, and irrigation.

Refuse Collection

The final design of the refuse collection area is not noted on the Site Plan; however, the applicant has noted to Staff that inclusion of such facilities will be added to the final site design. Therefore, Staff has included Condition 19 requiring the addition of refuse collection facilities, subject to review and approval by City Staff and the City's contracted refuse collection agency (Burrtec).

Street Improvements

Balsam Road will be improved to include curb, gutter, and sidewalk where not installed, and ADA compliant pedestrian routes will be added to all driveways included within the projects scope of work. The applicant/developer will also be required to provide an inlieu fee for the future completion of the site's Huerta Road frontage, which is acceptable given the undetermined need for said right-of-way that is dependent upon future development patterns in the vicinity. Engineering Conditions 37 & 38 have been included in order to ensure street improvements are required as discussed.

Parking & Circulation

- Parking standards for a distribution warehouse such as this proposal require 19 employee/patron spaces for the first 16,000 sq. ft. of warehouse space plus 1 space for each 2,000 sq. ft. of warehouse area in excess of 16,000 sq. ft. Therefore, based upon the approx. 126,000 sq. ft. of warehouse area, 74 off-street parking spaces are required on the subject site (110,000 sq. ft. / 2,000 sq. ft. = 55 spaces + 19 spaces [First 16,000 sq. ft.] = 74 total spaces). As proposed, the site provides parking in accordance with Title 16 standards as over 140 employee patron spaces are proposed and 75 are required, resulting in a surplus of approximately 65 spaces. Additionally, Staff has included Condition 11 requiring all employee/patron parking to meet minimum size (9'x20' parking spaces) and access (26' wide drive aisle) requirements of the V.M.C.
- The project site shares access and drive aisles along the southern property lines that will be adjusted in conjunction with the proposed redevelopment. Therefore, to ensure all parking areas on-site and off-site retain access in accordance with V.M.C. standards, Staff has included Condition 13 requiring such.
- Reciprocal access is required where abutting parcels are used for shared site access and parking. Therefore, Condition 14 has been added to confirm any existing CC&Rs are not compromised in conjunction with the subject project.

Delivery Vehicle Screening

• Although over 140 off-street parking spaces are provided for employees and patrons that are landscaped and designed in accordance with the V.M.C., there are approximately 650 delivery vehicle spaces and staging areas that are not landscaped per V.M.C. standards. Inasmuch as the subject delivery spaces are not required parking and because the subject parking areas are not accessible by the general public, Staff finds that these parking areas can be considered exempt from typical parking standards (e.g. size, access, and landscaping) if screened from public view. Therefore, Condition 17 has been added in order to require screening in the form of landscaping and walls or fencing in conjunction with the issuance of a building permit.

Miscellaneous

- Overhead utility lines dissect the center of the site running east to west; however, their relocation to underground is not anticipated to be required pursuant to Section 16-5.12.170 of Development Code since utility lines designed for over 34.5 kV nominal are exempt from the underground requirement. Therefore, Condition 24 has been included to confirm the voltage of the utility lines accordingly.
- Comments from the City's refuse collection contractor (Burrtec) and the regional air quality management district (Mojave Desert Air Quality Management District) have been received (Attachment D), which have been addressed via Conditions 19 & 28-32 to ensure compliance with the regulatory agencies standards.
- Signage is included in the Site Plan; however, the project includes freestanding signage in excess of the allowances provided by Section 16-3.22.130 of the V.M.C. Therefore, Condition 25 & 26 has been added in order to ensure any signage in excess of V.M.C. allowances is reviewed and approved by the Planning Commission accordingly.
- A lot merger is typically required where a single land use is proposed to encompass multiple parcels. Therefore, Condition 27 has been added in order to merger the subject parcels unless otherwise deemed unnecessary by the Zoning Administrator.

Scope of Review

- In accordance with Section 16-3.01.030 of the Development Code, Staff finds that the proposed Minor Site Plan meets the requirements of Title 16 as follows:
 - The location of the site as conditioned with screened delivery vehicle parking areas, roll-up bay doors oriented away from neighboring rights-of-way and residences, and enhanced landscaping will conform to the physical constraint of the existing site by reducing views of on-site operations while improving and revitalizing existing site improvements; and
 - Adverse impacts to surrounding properties will be minimized due to the proposals site improvements including enhanced landscaping, screening of delivery vehicle storage areas, and building updates that are designed accommodate site operations without introducing adverse impacts or view to neighboring properties, which will improve the overall aesthetics of the site; and
 - Surrounding uses will be minimally disrupted due to the proposals scope and improvements which will screen most of the proposed operations from public view and improve the public right-of-way; and
 - As proposed, the Minor Site Plan substantially fulfills the applicable requirements of the Commercial Design Guidelines and the Development Code due to enhanced landscaping, screening, updated building design, and street improvements with compliant site access.

3. Minor Interim Use Permit.

Use History

 The subject site has previously been used by a retail establishment as well as a drive-in movie theater with no businesses operating at either location for over eight years (20+ years of vacancy at the drive-in site). City Staff has reviewed few site reuse proposals at the subject site within the last eight years and no proposal has included the reuse of the entire retail building as included in the subject project.

Business Operations

- The proposed Interim Use Permit seeks to utilize the existing site (including reuse of the existing building to accommodate a parcel delivery service as a single tenant.
- Hours of operation for the proposed business include operations 24 hours a day seven days a week, with actual delivery from the site occurring between the hours of 9AM-9PM. Eighteen line haul trucks (e.g. tractor trailer trucks) are anticipated to visit the site daily, after which packages are unloaded and prepared for final "last mile" delivery in the local and surrounding communities. Additionally, 150 employees are scheduled to Staff the facility daily split between a 1:30AM-12:30PM shift (approximately 105 employees) and a 1PM-10PM shift (approximately 45 employees).
- Delivery from the site to customers will take place in a variety of methods such as delivery service partners (private businesses in tenant branded vehicles stored on-site) and independent contractors (in private vehicles), with delivery service partners vehicle loading beginning at 8:30AM and waves of approximately 50 vehicles departing the facility every 30 minutes between 9AM-11AM. After delivery vehicle dispatch, delivery service partner vehicles will return to the site between 7PM-9PM where vehicles are parked on-site. Independent contractors will visit the site in the afternoons from 4PM-5PM with staggered departure every 20 minutes during this time and private vehicles used and stored off-site.
- Accessory uses within the existing building include office area, staff support areas (e.g. restrooms, break rooms, etc.), as well as a "Hub" customer service area where customers can pick-up or return items in lieu of delivery. The total accessory use area comprises approximately 10,250 sq. ft. of the 126,000 sq. ft. building with the customer service area utilizing approximately 750 sq. ft. of said accessory area. The subject customer service area is noted to operate between 10AM-9PM and includes sufficient on-site parking in accordance with Title 16 standards given the 65 space surplus noted in the Site Plan discussion.
- In order to ensure all sorting operations are conducted indoors as required by the Development Code, Staff has included Condition 3 requiring such. Additionally, delivery vehicle parking areas are proposed at the north end and south end of the site with limited interior landscaping improvements. Staff finds that this design should not negatively affect the public health, safety or welfare due to this area being restricted access and screened by landscaping as well as a wall or fence along the right-of-way in order to reduce adverse impacts to neighboring properties. Provided loading/unloading of vehicles is not performed in this area as required by Condition 3, Staff finds the proposed design acceptable.

4. City Council Policy Findings

• The General Commercial Zone District (C-2) does not permit the proposed parcel delivery service as a permitted or conditional use. However, an interim use within the C-2 District is permitted if the proposed use meets the requirements of the City Council Policy for Interim Uses (CP-11-05). Staff finds that the parcel delivery service at this location does meet the requirements of the Council Policy as discussed in the following section.

Basis of Need:

The proposal is located within an existing building that has had difficulty in obtaining a suitable tenant given the facility's size and location setback form Bear Valley Road with numerous vacancies also present within the adjoining shopping center. Economic decline and shifting land use patterns away from big box retailers to e-commerce have caused the subject site to remain vacant for over eight years after the previous tenant relocated to a new facility along Interstate 15 with improved visibility. Therefore, based upon the circumstances noted above, Staff finds the site meets the basis of need requirement.

o Required Findings:

- i) The proposed use is 'similar' to other permitted uses within the zone in regards to:
 - Hours of Operation Typical daytime and evening business hours for customer service operations that are not uncommon for commercial uses in the area, with delivery and support operations throughout the day located indoors and screened from public view, in a manner similar to retailers receiving stock shipments in the evening/morning hours.
 - Parking Needs/Requirements Adequate parking on-site in accordance with Title 16 standards.
 - Traffic Impacts Access from abutting Balsam Road should be adequate to serve proposal with street improvements included and staggered vehicle departures proposed. Additionally, a traffic study found the impacts from this proposal to be less than those of the previously existing retailer.
 - Occupancy Patterns The utilization of previous "big box" retail location will introduce a similar traffic flow and employee/customer base to the location as previously supported by the location.
 - Noise Noise impacts should be minimal as the project will mitigate any noise created by the use through landscape and wall/fence screening, and all work is conditioned to be performed indoors or adjacent to the building.
 - Environmental Impacts The use should not produce any negative environmental impacts as conditioned and with the issuance of required building permits.
 - Required Licensing/Permits Any required permits can be obtained during the Business License phase of the entitlement as well as during plan check with the Building Division.
 - Required Facilities The site contains restroom facilities that should be adequate to serve the proposed use and handicapped access and parking appears adequate as proposed.

- ii) The proposed use is a 'good fit' in regards to:
 - Existing Structures The proposal is located within an existing building that will be modified to accommodate the proposed use and the size of the existing single-tenant site will allow all sorting functions to be performed indoors.
 - Existing Site Development/Conditions The site will be improved per the associated Minor Site Plan entitlement to add landscaping, screening, revised parking lot design, and updated the refuse collection in accordance with the Development Code.
 - Compatibility with Adjacent Existing & Permitted Uses The proposal is bound on three sides by commercial property and on remaining side by a Circulation Element designated Arterial right-of-way that separates the proposal form single-family residences. Due to the surrounding commercial development, landscaping and screening proposed, as well as the existing right-of-way frontage, the proposal should be compatible with the surrounding uses and mitigate potential impacts accordingly.
- iii) The proposed use presents no negative impacts to any of the following:
 - Public Interest The use will not have a negative impact on public interest as
 the site has been vacant for over eight years with vandalism and loitering
 prevalent at the subject site. Redevelopment of the site to accommodate a
 parcel delivery service will introduce activity in the area as well as support
 surrounding businesses in a manner that will benefit the aesthetics and
 economic vitality of the community.
 - Public Health, Safety, and Welfare No negative impacts as conditioned and with required building permits, which will ensure approval by the local air quality management district.
 - Economic Vitality of the Area The use will fill a vacancy in an area and will improve the existing conditions on-site.
 - Neighboring Businesses and Residents No negative impacts are expected to local businesses due to the additional customers and employees that will likely patronize local business. Additionally, potential impacts to residents in the vicinity will be mitigated by enhanced landscaping, screening, indoor operations and staggered vehicle arrival/departure times.
 - Overall Integrity of the Center, District or Area The use will not negatively
 affect the integrity of the area due to numerous vacancies in the underlying
 shopping center and a new customer base that will be created for businesses in
 the vicinity.
 - Does not Contribute to Over-Concentration N/A

IV. SITE CHARACTERISTICS:

		General Plan	Zoning	Specific Plan District
Site	Vacant Commercial Building	Commercial	C-2	N/A
North	Vacant Drive-In Theater Parking Field	Commercial	C-2	N/A
South	Multi-tenant Commercial	Commercial	C-2	N/A
East	Single-Family Residences	Very Low Density Residential	R-1TB½	N/A
West	Multi-tenant Commercial / Vacant / Self-Storage	Commercial	C-2 / C-M	N/A

NUMBER OF RADIUS LETTERS MAILED: 34

ΑJ

Attachments:

Attachment A – Site Plan

Attachment B – Project Description

Attachment D – Agency Comments
Attachment E – Aerial Image

CONDITIONS OF APPROVAL - MINOR SITE PLAN ADMN20-00096 December 16, 2020

A MINOR SITE PLAN WITH AN ENVIRONMENTAL EXEMPTION TO ALLOW FOR SITE IMPROVEMENTS ASSOCIATED WITH A PARCEL DELIVERY SERVICE WITHIN AN EXISTING COMMERCIAL BUILDING ON A C-2 ZONED PROPERTY LOCATED AT 15272 BEAR VALLEY ROAD

Planning Conditions:

- 1. This approval is to allow for site improvements to a vacant single-tenant commercial building and adjacent vacant parking fields on property located at 15272 Bear Valley Road as well as the property north of and abutting the subject location. Approved site improvements include building elevation changes (including storefront changes, additional roll-up doors and building access, as well as paint/material updates), a redesigned floor plan, addition of a covered loading/staging canopy, on-site circulation redesign, parking area redesign and repair, the addition of walls and/or wrought iron fencing with masonry pillars, new and updated landscaping, and required street improvements.
- 2. The proposed development shall comply with all applicable development standards of Title 16 and shall be in general compliance with the Commercial Design Guidelines.
- 3. The proposed development shall be in substantial conformity with the plans submitted as part of this application, unless modification is required to comply with the applicable development standards of Title 16 and/or conditions of approval.
- 4. The development shall be in substantial conformity with the architectural elevations and renderings submitted with this application, unless modification is required by condition.
- 5. The applicant shall provide a materials and color sample board prior to the issuance of a building permit.
- 6. Any change in use, including such changes as the expansion of on-site guest services (e.g. package pickup and return services) or implementation of a new use within the facility, which will require additional employee and/or guest parking spaces shall be reviewed and approved by the Zoning Administrator prior to implementation. Any change resulting in noncompliance with the parking standards of Title 16, shall cause that use to be subject to Planning Commission review and approval.
- 7. Should a parking shortage occur on-site (e.g. employees, customers, or delivery vehicles parking off-site due to unavailability of parking on-site), as witnessed by City Staff via complaint or in person site visits and verified by the Zoning Administrator, the applicant shall immediately provide delivery vehicle parking spaces for use by employees and patrons of the site, subject to review and approval by the Zoning Administrator via revised site plan. Based upon the severity of any future parking shortage on-site, the Zoning Administrator may require a Site Plan Modification and/or a new Interim Use Permit.
- 8. The number and location of all handicapped parking spaces shall be subject to Development Department review and approval.
- 9. In the event the applicant/developer proposes to gate any of the vehicular driveway entrances shown on the site plan, approval of a subsequent Minor Site Plan application shall first be obtained unless

otherwise approved by the Zoning Administrator via building permit prior to the issuance of the original Certificate of Occupancy.

- 10. All existing parking areas that will not be repaided (including employee, customer, and delivery vehicle areas) shall be patched and repaired with a finish slurry seal coat and parking stall restriping unless deemed unnecessary by the Zoning Administrator.
- 11. All required employee and customer parking spaces and drive aisles shall be designed in compliance with Section 16-3.21.050 of the V.M.C., including 9'x20' parking spaces dimensions and 26' wide drive aisles.
- 12. Service fleet vehicles shall not park within required employee and customer parking spaces. Signage to prevent unauthorized vehicular access and parking shall be indicated on the site plan.
- 13. The off-site parking area that is currently within the property boundary shall be redesigned or adjusted to avoid dead end drive aisles and include planters at the end of parking rows to match existing conditions. These improvements shall be included in the Site Plan for review and approval prior to the issuance of a building permit, including parking space and drive aisle design in accordance with Section 16-3.21.050 of the V.M.C.
- 14. Prior to the issuance of a building permit updated reciprocal access shall be required or proof of existing reciprocal access between the subject site and the remainder of the shopping center (e.g. CC&R's, recorded agreements, etc.) that allows the proposed changes shall be submitted for review.
- 15. A six-inch wide planter curbing, in accordance with Engineering Standard S-09, is required along the perimeter of all landscaped areas, including planters that abut the public right-of-way sidewalk. All planter strips abutting a public right-of-way and planter islands/landscape fingers shall be a minimum interior width of five feet, exclusive of curbing. The grading and site plans shall clearly show all required curbing.
- 16. The applicant/developer shall provide landscaping/irrigation plans in accordance with Chapter 13.60 of the Victorville Municipal Code, entitled Water Conservation. Landscape areas shall not exceed a slope of 3:1 and shall also meet Title 16 standards, including the minimum interior percentage of landscaping and the maximum dispersal of landscaping within a parking lot, excluding the screened service parking field to the north of the building. The landscaping plan shall include a minimum of one 24-inch box tree for every eight parking spaces provided on-site located within minimum 5-foot interior width planters. In addition, the landscaping plan shall include the maximum spacing of all plants as follows:
 - A. Ground cover eighteen inches on center
 - B. One gallon plants three feet on center
 - C. Five gallon plants five feet on center

In addition, a note shall be conspicuously placed on the landscape plan indicating the following: Any discrepancy between the maximum spacing criteria and the number of plants shown on the landscape plan shall result in the spacing criteria superseding any other information shown on the landscape plan.

- 17. Required screening of parking areas shall be provided and noted on the Site Plan prior to the issuance of a building permit as follows:
 - i. Huerta Road A minimum 10' landscape planter (which may be designed to accommodate stormwater drainage) with 24"-36" box trees and other landscaping as well as a wrought iron fence with decorative masonry pillars at least 6' in height located at the 10' setback.
 - ii. Balsam Road (North of Building Edge) A minimum 10' landscape planter (which may be designed to accommodate stormwater drainage) with 24"-36" box trees and other landscaping as well as a decorative masonry wall with pilasters or a decorative view obstructing panel wall/fence with decorative masonry pillars at least 6' in height located at the 10' setback, subject to the review and approval of the Zoning Administrator. Alternative means of screening the public views of this parking area shall be established within the SCE easement, should SCE provide written correspondence that the above-mentioned screening method and improvements are not acceptable, subject to the review and approval of the Zoning Administrator.
 - iii. Balsam Road (Approx. East of and Adjacent to Building) Provide 10' landscape planter (which may be designed to accommodate stormwater drainage) with 24"-36" box trees and other landscaping.
 - iv. West Property Line Wrought iron fence at least 6' in height.
 - v. South Property Lines (Abutting Shopping Center) 5' interior width landscape planter (which may be designed to accommodate stormwater drainage) with 24"-36" box trees and other landscaping sufficient to screen parking areas not improved in accordance with Title 16.

The final design of the landscaping, screening, walls and/or fences shall be subject to final review and approval by the Zoning Administrator in accordance with Title 16 standards prior to the issuance of a building permit.

- 18. All existing and proposed landscaped areas shall be maintained in a neat, clean, orderly and healthful condition. This includes proper pruning, mowing of lawns, weeding, removal of litter, fertilizing, replacement of plants when necessary and the regular watering of all plants. In addition, all landscaped areas shall be provided with a suitable permanent water system. (This condition shall require the replanting of the existing planter along the west property line that is not currently shown on the submitted site plan)
- 19. The applicant shall install a trash enclosure in conformance with Section 16-3.24.110 of the Victorville Municipal Code. The enclosure shall have solid block walls with non-transparent metal gates, a solid roof/cover that is architecturally compatible with the primary building(s) onsite and serves to protect the refuse area from inclement weather, as well as wrought iron that fully encloses the trash enclosure between the block wall/metal gates and the roof to prevent unauthorized entry. Additionally, all trash enclosures shall include "walk-in" rear or side access for pedestrian use. The location, design and quantity of said enclosures shall be subject to Burrtec and Zoning Administrator review and approval.
- 20. Any new rooftop and/or ground mounted equipment visible from public rights-of-way shall be screened from view and architecturally integrated into the building.
- 21. Any new wall mounted utility equipment (i.e. meters, panels, boxes, conduit etc.) shall not be visually exposed on the building. This type of equipment shall be internally located, screened with landscaping or covered in a manner that is architecturally integrated into the design of the building, subject to the review and approval of the Zoning Administrator.

- 22. Any new roof drains (i.e. scuppers and down spouts) shall not be visually exposed on the building(s). Roof drains shall be internally located, subject to the review and approval of the Zoning Administrator.
- 23. A photometric study and site lighting plan shall be included within the architectural and/or civil improvement permit sets.
- 24. Prior to the issuance of a building permit, the applicant/developer shall provide verification that the electrical transmission lines traversing the center of the site from east to west are designed for over 34.5 kV nominal. Should these transmission lines be designed for less than 34.5 kV nominal, the applicant shall be required to relocate said transmission line underground unless otherwise waived by the City Engineer or suspended by the Planning Commission with proper application and fee's submitted by the applicant/developer.
- 25. All proposed signs, including any freestanding signage, shall comply with Title 16. The applicant shall be required to submit a sign package for review and must gain approval by the Planning Commission prior to approval of any signage proposed which is inconsistent with Title 16. Any new freestanding signs on-site may trigger the requirement of a Master Sign Program for the entire Shopping Center, as required by Sec. 16-3.22.170. All signs shall be subject to Planning Staff review and approval prior to obtaining a building permit.
- 26. All proposed temporary signage shall comply with Title 16. All temporary signs (grand openings, special sales, etc.) shall only be affixed to the suite they serve in accordance with an approved Temporary Sign Permit. Flags or other off-site signage is prohibited within multi-tenant developments.
- 27. A lot merger may be required including application, approval, and recordation prior to issuance of the Certificate of Occupancy for the subject site. The Zoning Administrator may waive this requirement based upon justification from the applicant/developer noting conditions that inhibit the merger of the subject parcels (e.g. conflicts with CC&R's, interference with existing agreements or easements, etc.).
- 28. A dust control plan will be required for the parking lot portion of the project, subject to review and approval by the Mojave Desert Air Quality Management District prior to the issuance of a building or grading permit.
- 29. Signage complaint with Rule 403 Attachment B shall be erected at each project site entrance no later than commencement of construction, subject to review and approval by the Mojave Desert Air Quality Management District prior to the issuance of a building or grading permit.
- 30. The applicant/developer shall use a water truck to maintain moist disturbed surfaces and actively spread water during visible dusting episodes to minimize fugitive dust emissions. If the project includes exposed sand or fines deposits (including exposing such soils through earthmoving), chemical stabilization or covering with a stabilizing layer of gravel will be required to eliminate visible dust/sand from sand/fines deposits.
- 31. Prior to the issuance of a demolition permit an asbestos survey and notification will be required if deemed necessary by the Mojave Desert Air Quality Management District.
- 32. Prior to the issuance of a building permit the applicant shall evaluate the project impacts via the CalEEMod methods (or the equivalent) to determine the impacts to sensitive receptors outlined in

the Mojave Desert Air Quality Management District (MDAQMD) and CEQA guidelines. If the project is deemed to result in a cancer risk greater than or equal to 10 in a million and/or Hazard Index (HI)(non-cancerous) greater than or equal to 1, the applicant/developer/tenant will be required to incorporate mitigation measures sufficient to reduce project impacts to a level that is not significant, subject to review and approval by MDAQMD prior to the issuance of a building permit.

- 33. Prior to the release of any utilities for the use, all Title 16 improvements for the project shall be installed or a bond posted in the amount of one hundred fifty percent (150%) of the value of the uncompleted work shall be submitted to the Zoning Administrator, unless otherwise deemed unnecessary by the Zoning Administrator. Any modifications to the amount of the bond shall be subject to review and approval by the Zoning Administrator only if found by the Zoning Administrator that there are circumstances unique to the use that is not applicable to other uses.
- 34. The applicant/developer shall be responsible for obtaining all necessary permits from any affected regulatory agencies.
- 35. The Applicant/Owner shall agree to defend, indemnify and hold harmless, the City of Victorville, its agents, officers and employees from any claim, action or proceeding against the City of Victorville or its agents, officers or employees to attack, set aside, void or annul this approval. The City of Victorville shall promptly notify the applicant of any such claim, action or proceeding, and the City of Victorville shall cooperate fully in the defense.
- 36. The project shall comply with all Federal, State and local laws and policies, including: the California Government Code (including the Planning, Zoning and Development Laws), Environmental Quality Act (CEQA), Subdivision Map Act, International Building Code, Green Code, Fire Code; and, Victorville General Plan and Municipal Code; unless permitted to deviate through provisions of such, or through adopted mitigation measures, conditions of approval, or the plans themselves.

Engineering Conditions:

- 37. The developer shall dedicate an easement for public right-of-way to the City of Victorville for the following in accordance with the Circulation Element of the General Plan:
 - i. 42 feet from the centerline of improvements for Balsam Road for APN No. 3093-271-07.
- 38. The developer shall install all improvements required by Section 9.32.040 of the Victorville Municipal Code (including curbs, gutters, sidewalks, pavement widening, drive approaches, street lighting, and drainage facilities) along the street frontages of the project (Balsam Road and Huerta Street), in accordance with the Standard Specifications for Public Improvements of the City of Victorville. The required street improvements include:
 - i. The commercial driveways on Balsam Road shall be removed & replaced per City Standard No. S-03.
 - ii. The existing public fire hydrants on Balsam Road shall be relocated to match City Standard No. S-12.
 - iii. Balsam Road frontage improvements for APN No. 3093-271-07. These improvements include but are not limited to pavement widening, curb & gutter, commercial sidewalk, driveway approaches, street lighting and drainage structures to City standards.
 - iv. Huerta Road frontage improvements for APN No. 3093-271-07. These improvements include but are not limited to grading, base, pavement, curb & gutter, AC Berm, commercial sidewalk, driveway approaches, street lighting and drainage structures to City standards. The City will consider an in-lieu fee for the Huerta Street Improvements based on the approved Engineer's Cost Estimate.

- v. Balsam Road shall be re-striped from Bear Valley Road to Huerta Street to provide for a striped median, i.e. a double left turn pocket. The developer shall prepare street improvement and striping plans for Balsam Road for City review and approval that provide for the removal of the existing striping, installation of a crack seal and slurry seal, and new thermoplastic striping.
- 39. In accordance with State Water Quality Resources Board requirements, the developer shall implement measures for site design, source control, run-off reduction, storm water treatment and baseline hydro modification as defined by the Phase II Small MS4 Permit. This includes measures installed such that post-development peak storm water runoff discharge rates do not exceed the estimated pre-development rate, and on-site post-construction BMPs for treatment of storm water run-off.
- 40. The developer shall prepare a water quality management plan for the on-site post-construction BMPs for treatment of storm water run-off. The project property owner shall enter into a maintenance agreement with the City for the water quality management plan.
- 41. A grading plan/site improvement plan shall be submitted to the Development Department for review and approval. The grading plan shall address all on-site and off-site drainage issues, including nuisance water and flows entering and exiting the site. A final drainage study shall be submitted with the grading plan. The developer shall provide hydrology and hydraulic calculations to size any drainage structure included in the grading plan design.
- 42. Grading operations and construction shall be conducted in a manner and/or measures taken to prevent sand, dust, and debris to blow onto other properties. An adequate dust palliative shall be used at all times. After completion of grading the developer shall maintain the site such that sand, dust and debris do not blow onto other properties.
- 43. Temporary fencing shall be erected as required by City staff during construction to prevent windblown debris from leaving the project site and to ensure public safety.
- 44. A reduced pressure backflow device per City standard W-39 must be installed behind the domestic water meter serving the site. A Fire Service Reduced Pressure Detector Assembly per City standard W-28 shall be installed on the fire protection service if on-site protection is required. The developer shall submit plans for fire hydrant relocations, new backflow devices, and new service connections to the Development Department for review and approval by the City Engineer. A current water service will serve letter from Victorville Water District is required with the plan submittal. Water service shall be subject to the conditions within the will serve letter.
- 45. A permit issued from the City's Engineering Department is required prior to commencement of any work performed within public right-of-way and the City's inspection process followed for the connection to and construction of any facilities that are to be dedicated to, owned and maintained by the City.
- 46. All public utility distribution lines, including service lines to the site, shall be installed by the developer.
- 47. The developer shall be responsible for all costs (including application fees) incurred due to the relocation of existing utility facilities where such facilities conflict with the improvements associated with this project.

- 48. Landscaping within the traffic sighting distance triangle at intersections and driveway connections to public streets shall be limited to ground cover only and shall not include shrubs and trees.
- 49. The developer shall pay any and all fees and charges that may become effective prior to the issuance of a building permit or utility connection, and shall pay such fees as a condition of obtaining a building permit.
- 50. Prior to construction of any improvements or any land disturbance, the developer shall construct temporary drainage facilities and provide erosion control measures as necessary to minimize storm water run-off, erosion, and silt deposition. The developer shall provide an erosion control plan of the Best Management Practices to be implemented during construction. The National Pollutant Discharge Elimination System (NPDES) stormwater permit program requires operators of construction sites one acre or larger (including smaller sites that are part of a larger common plan of development) to obtain an NPDES permit, and prepare a Storm Water Pollution Prevention Plan (SWPPP). A copy of the SWPPP, and an erosion control plan shall be submitted to the Development Department. All NPDES guidelines must be adhered to, and best management practices followed at all times during construction.
- 51. A boundary survey must be performed and property corners verified prior to construction to facilitate the placement of improvements per plan direction. The developer's engineer shall provide a horizontal control plan to the City for review or provide adequate control/dimensioning on the site/grading plan.
- 52. The method of installation (trenching or boring) for connections to existing utilities (sewer, water, storm drain, etc.) within paved streets shall be subject to approval by the City Engineer.
- 53. On-site drainage to streets shall be conveyed through parkway drains or as approved by the City.
- 54. Pursuant to Section 16-5.12.170 of the City's Municipal Code, the owner/developer must underground the existing above ground utilities along the Balsam Road frontage and the project site if the electrical lines are 34,000 volts or under. The site plan must be revised to show the existing power poles and the required undergrounding.
- 55. An application for plan review and an engineer's construction cost estimate for civil improvements shall be required at the time of initial improvement plan submittal. Payment of plan and map check fees as per the City's Development Department Engineering Plan Check Fee Schedule based on the engineer's cost estimate shall be required with the plan submittal.

Fire Conditions:

- 56. Shall comply with all Building and Fire Code requirements based on occupancy classification.
- 57. Monitored fire sprinkler system(s) are required for the proposed building(s). Plans shall be submitted prior to construction.
- 58. Monitored fire alarm system(s) are required for proposed building(s). Plans shall be submitted prior to construction.
- 59. An approved on-site fire protection system, in accordance with Fire and Water Department Standards is required.

- 60. Provide a preliminary on-site fire protection plan which indicates the location of all required fire protection appliances (FDC's, PIV's, RP's, hydrants, etc.) Required appliances shall be unobstructed by fencing, storage containers, parked vehicles, etc.
- 61. Knox Box/Key Box is required and shall be provided and installed in accordance with Fire Department Standards.
- 62. Access gates shall be provided with an "Opticom" receiver capable of opening gates via decoding of the "Opticom" strobe signal transmitted by Fire, Police, and Ambulance units. All access gates shall require mechanical means for opening in event of power failure, shall not impinge on required clear width when fully open, and shall be equipped with Knox Box lock actuation devices.

Building Conditions:

- 63. The project shall comply with all building codes in effect at the time of plan submittal.
- 64. The scope of work indicated will require accessibility upgrades to be included in accordance with Section 11B-202 of the California Building Code.
- 65. Plan check fees for this project will be due, and shall be paid in full, upon submittal of plans to the Building Division. The Building Division may be contacted at (760) 955-5100 for an estimation of these fees. Tools for estimating total permit fees are available on the City's website at https://www.victorvilleca.gov/government/city-departments/development/permit-center/fees-forms. Actual amounts owed will be determined upon submittal of the plans via the City's online permit center.

CONDITIONS OF APPROVAL - MINOR INTERIM USE PERMIT ADMN20-00096 December 16, 2020

A MINOR INTERIM USE PERMIT WITH AN ENVIRONMENTAL EXEMPTION TO ALLOW FOR THE ESTABLISHMENT OF A PARCEL DELIVERY SERVICE WITHIN AN EXISTING COMMERCIAL BUILDING ON A C-2 ZONED PROPERTY LOCATED AT 15272 BEAR VALLEY ROAD

Planning Conditions:

- 1. This approval is to allow for the operation of a parcel delivery service with accessory office and customer service area (e.g. package pick-up and return) located at 15272 Bear Valley Road. Facility hours of operation are 24 hours a day seven days a week with general functions as follows:
 - Facility Operations 24 hours a day seven days a week with 1:30AM-12:30PM shift (approximately 105 employees) and a 1PM-10PM shift (approximately 45 employees).
 - Delivery Operations Loading beginning at 8:30AM and waves of approximately 50 delivery service partner vehicles departing the facility every 30 minutes between 9AM-11AM.
 Delivery service partner vehicle will return between 7PM-9PM where vehicles are parked onsite. Independent contractors loading/departure from 4PM-5PM with staggered departure every 20 minutes.
 - Customer Service Operations (In person) 10AM-9PM daily.

The Zoning Administrator may allow revised hours of operation and accessory or revised services not listed in this approval, providing the primary use does not change and the changes do not negatively affect the public health, safety, and welfare nor cause nonconformance with the City Council Policy for Interim Uses (CP-11-05).

- 2. Approval of this Minor Interim Use Permit shall be contingent upon the completion/fulfillment of the Conditions of Approval included with the associated Minor Site Plan Conditions of Approval.
- 3. All package sorting shall be performed indoors with delivery vehicle loading/unloading to take place within or directly adjacent to the building or within the staging canopy area. Additionally, no vehicle repair shall be performed on-site.
- 4. The proposed improvements and use shall comply with all applicable development standards of Title 16.
- 5. The proposed improvements and use shall be in substantial conformity with the plans submitted as part of this application, unless modification is required to comply with the applicable development standards of Title 16, and/or conditions of approval.
- 6. Any expansion of the proposed use beyond the scope of this interim use permit shall require submission and approval of an interim use permit modification or a new interim use permit based upon the extent of the expansion.
- 7. Any change in use, including such changes as the expansion of on-site guest services (e.g. package pickup and return services) or implementation of a new use within the facility, which will require additional employee and/or guest parking spaces shall be reviewed and approved by the Zoning Administrator prior to implementation. Any change resulting in noncompliance with the parking

- standards of Title 16, shall cause that use to be subject to Planning Commission review and approval.
- 8. Should a parking shortage occur on-site (e.g. employees, customers, or delivery vehicles parking off-site due to unavailability of parking on-site), as witnessed by City Staff via complaint or in person site visits and verified by the Zoning Administrator, the applicant shall immediately provide delivery vehicle parking spaces for use by employees and patrons of the site, subject to review and approval by the Zoning Administrator via revised site plan. Based upon the severity of any future parking shortage on-site, the Zoning Administrator may require a Site Plan Modification and/or a new Interim Use Permit.
- 9. The applicant/business owner shall be responsible for obtaining all necessary permits from any affected regulatory agencies.
- 10. The Applicant/Owner shall agree to defend, indemnify and hold harmless, the City of Victorville, its agents, officers and employees from any claim, action or proceeding against the City of Victorville or its agents, officers or employees to attack, set aside, void or annul this approval. The City of Victorville shall promptly notify the applicant of any such claim, action or proceeding, and the City of Victorville shall cooperate fully in the defense.

Fire Conditions:

- 11. Shall comply with all Building and Fire Code requirements based on occupancy classification.
- 12. Monitored fire sprinkler system(s) are required for the proposed building(s). Plans shall be submitted prior to construction.
- 13. Monitored fire alarm system(s) are required for proposed building(s). Plans shall be submitted prior to construction.
- 14. An approved on-site fire protection system, in accordance with Fire and Water Department Standards is required.
- 15. Provide a preliminary on-site fire protection plan which indicates the location of all required fire protection appliances (FDC's, PIV's, RP's, hydrants, etc.) Required appliances shall be unobstructed by fencing, storage containers, parked vehicles, etc.
- 16. Knox Box/Key Box is required and shall be provided and installed in accordance with Fire Department Standards.
- 17. Access gates shall be provided with an "Opticom" receiver capable of opening gates via decoding of the "Opticom" strobe signal transmitted by Fire, Police, and Ambulance units. All access gates shall require mechanical means for opening in event of power failure, shall not impinge on required clear width when fully open, and shall be equipped with Knox Box lock actuation devices.

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ATTACHMENT A

60633050

SITE IMPROVEMENTS **FOR DFX4 DELIVERY CENTER**

15272 Bear Valley Road, Victorville, CA 92395

APN: 3093-291-01 3093-271-07

SHEET INDEX

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C1.02		EXISTING CONDITIONS 2
C1.03		CIVIL DEMOLITION PLAN
C1.04		CIVIL SITE PLAN
C1.05		GRADING & DRAINAGE 1
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L2.10		IRRIGATION PLAN - SOUTH
L2.11		IRRIGATION PLAN - NORTH
L2.20		IRRIGATION DETAILS
L2.21		IRRIGATION DETAILS





CITY OF VICTORVILLE ENGINEERING DEPARTMENT

Printed on 30% Post-Cons Recycled Content Paper

Chuck E. Cheese

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NOT TO SCALE

PROJECT SITE

VICINITY MAP

Victorville, CA

ABBREVIATION WORD LEGEND EXISTING NEW FLARED END SECTION FINISH FLOOR FINISH FLOOR ELEVATION OUTSIDE DIAMETER OVERHEAD ELECTRIC CONTOURS (5' & 10') SPOT ELEVATION X 200.50 AVERAGE EDGE OF PAVEMENT PROPERTY LINE FOR CURB & GUTTER BEARING BENCH MARK BEVELED END SECTION BOTTOM OF BUILDING FIRE WATER POUNDS PER SQUARE INCH EDGE OF UNPAVED/GRAVEL PROPERTY LINE GALV GI GRAD GRD GRD GALVANIZE GRATE INLET BLDG RIGHT OF WAY - R/W -GRADING GROUND GRADE R RCP REF REINF REINFORCED CONCRETE PIPE LIMITS OF DISTURBANCE REFERENCE REINFORCING REQUIRE REQUIRED SILT FENCE FENCE LINE HIGH DENSITY POLYETHYLENE CENTER TO CENTER HIGH POINT HORIZONTAL HEADWALL HYDRANT RIGHT RIGHT OF WAY CATCH BASIN GRATE CONTROL JOIN (SD) STORM MANHOLE CL CMP CMU CO COL CONC CONN CONT CS CTR CU FT CY SANITARY SEWER INCH INFORMATION INSIDE DIAMETER INTERSECT INVERT SCH SD (OR STRM) SDMH SDCB SIM SQ FT ÎN. (OR ") ÎNFO STORM UKANN STORM DRAIN MANHOLE STORM DRAIN CATCH BASIN SIMILAR SQUARE FEET STORM DRAIN SS CONCRETI SEWER CLEANOUT CONTROL S FIRE DEPARTMENT CONNECTION = STA SURF SURV SY SYM STATION SURFACE +0+ FIRE HYDRANT JUNCTION BOX SQUARE YARD SYMBOL Э POST INDICATOR VALVE BACKFLOW PREVENTER LATITUDE LIP OF GUTTER LONGITUDE LOW POINT LEFT LAT LIP OF GUTTER IRRIGATION BOX TOP OF CURE BASIN GRATE DEGREE DETAIL DROP INLET LONG L.P. LT IRRIGATION TOP OF BANK TYPICAL WATER METER ₩ DIAMETER DIMENSION DUCTILE IRON PIPE MAX MECH MFR MH MI MIN MISC MPH MV ₩ wv WATER VALVE MAXIMUN U UNO UTIL TITLE TY VALLET U UNLESS NOTED OTHERWISE UTILITY ELECTRIC TRANSFORMER Æ E ELECTRIC VAULT EACH
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CONCRETE

ASPHALT PAVEMENT

BIOSWALE HATCH

GENERAL NOTES:

- A COMPLETE SET OF APPROVED DRAWINGS MUST BE MAINTAINED ON SITE AT ALL TIMES THAT THE CONTRACTOR IS
- WITHIN ALL NOTES, THE TERM CONTRACTOR SHALL MEAN THE GENERAL CONTRACTOR AND ANY SUBCONTRACTOR OR VENDOR PERFORMING CONSTRUCTION ON THE SITE.
- SHOULD THE CONTRACTOR FIND ANY DISCREPANCIES ON THE DRAWINGS OR IN THE FIELD PRIOR TO BEGINNING WORK OR DURING CONSTRUCTION, THE ENGINEER SHALL BE NOTIFIED IMMEDIATELY.
- THE CONTRACTOR IS RESPONSIBLE FOR VERIFYING ALL UNDERGROUND UTILITIES PRIOR TO CONSTRUCTION AND IS RESPONSIBLE FOR ANY DAMAGE TO THEM DURING CONSTRUCTION, CONTRACTOR SHALL CONTACT THE STATES LOCATION SERVICE AT LEAST 48 HOURS REPRO TO BEGINNING CONSTRUCTION.
- THE CONTRACTOR SHALL COMPLY WITH ALL RULES AND REGULATIONS OF FEDERAL, STATE, COUNTY AND LOCAL MUNICIPALITIES.
- ALL MATERIALS, METHODS AND DETAILS OF CONSTRUCTION SHALL CONFORM TO THE STANDARD SPECIFICATIONS OF THE LOCAL MUNICIPALITY AND/OR THE APPROPRIATE UTILITY COMPANY, WHICHEVER TAKES PRECEDENCE.
- THE CONTRACTOR IS REQUIRED TO MEET ALL APPLICABLE FEDERAL, OSHA, STATE, & LOCAL REGULATIONS CONCERNING PROJECT SAFETY AND ASSUMES FULL RESPONSIBILITY FOR SAFETY ON THE PROJECT.
- GENERAL CONTRACTOR SHALL VERIFY THAT ALL NECESSARY PERMITS FOR CONSTRUCTION HAVE BEEN OBTAINED PRIOR TO THE START OF THE PROJECT.
- ANY CONSTRUCTION TRAILERS USED ON-SITE SHALL BE PERMITTED THROUGH LOCAL GOVERNING AGENCY, IT SHALL BE THE CONTRACTOR'S RESPONSIBLITY TO ACQUIRE ALL NECESSARY PERMITS.
- GENERAL CONTRACTOR SHALL BE RESPONSIBLE FOR DAMAGES TO EXISTING INFRASTRUCTURE WITHIN THE SITE OR ADJOING PROPERTIES (I.P. PAREMENT, CURS, SISSEMULX, UTILITIES, LAUDICAPED AREAS INC.), CONTRACTOR SHALL REPRAIC REPLACE ALL DAMAGED ITEMS IMMERIATELY, F. NECESSARY, OR PRIOR TO THE END OF THE JOB AND AT NO COST TO THE OWNER IN ACCORDANCE WITH LOCAL REGULATOR REQUIREMENTS.
- THE GENERAL CONTRACTOR IS RESPONSIBLE FOR COORDINATING INSTALLATION OF ALL UTILITIES WITH THE APPROPRIATE UTILITY COMPANY AND SUBCONTRACTORS PREFORMING WORK TO AVIDIC CONFLICTS. GENERAL CONTRACTOR IS A SO RESPONSIBLE FOR SCHEDULING INSTALLATION OF ALL UTILIES IN A TIMEST, CONSTRUCTION STEMANTE, MANNER,
- IN THE EVENT OF A CONFLICT WITH WATER, SEWER, DRAINAGE OR OTHER UTILITY LINES, THE CONTRACTOR SHALL
 COORDINATE WITH THE ENGINEER PRIOR TO MAKING FIELD ADJUSTMENTS,
- THE CONTRACTOR IS RESPONSIBLE FOR THE REMOVAL AND DISPOSAL OF ALL RUBBISH, TRASH, DEBRIS, ORGANIC AND DEMOLISHED MATERIAL TO FACILITATE CONSTRUCTION OF THE PROPOSED IMPROVEMENTS IN A LEGAL MANNER.
- LOCATE, REMOVE, REPAIR AND REPLACE EXISTING LANDSCAPE IRRIGATION SYSTEM AS NECESSARY TO CONSTRUCT IMPROVEMENTS.
- UNLESS NOTED OTHERWISE SCARIFY, MOISTURE CONDITION AND COMPACT THE UPPER 6-INCHES OF SUBGRADE IN ALL NEW ASPHALT PAVEMENT AND CONCRETE WORK TO AT LEAST 95% RELATIVE COMPACTION.
- 16. PAVEMENT MARKINGS AND STRIPING SHALL BE THERMOPLASTIC. MATCH EXISTING STRIPING COLOR OR AS INDICATED IN
- THE CONTRACTOR SHALL PROVIDE BIORETENTION SOIL MIX SPECIFICATIONS FROM THE SUPPLIER FOR APPROVAL THAT
 MEET STATE, COUNTY AND LOCAL REQUIREMENTS PRIOR TO DELIVERY TO THE PROJECT SITE.

SITE AND ZONING NOTES:

- CURRENT ZONING IS GENERAL COMMERCIAL C-2.
- ADJUST PAVEMENT AND/OR CURBING ELEVATIONS AS NECESSARY TO ASSURE A SMOOTH TRANSITION AND CONTINUOUS GRADE TO ENSURE POSITIVE DRAINAGE.
- CONTRACTOR IS RESPONSIBLE FOR ALL UTILITY LOCATION WITH THE APPROPRIATE PROVIDER PRIOR TO COMMENCEMENT OF CONSTRUCTION

PRIMARY PERMITTEE: VICTORVILLE PLANNING DEPARTMENT PERMITTEE ADDRESS: 14343 CIVIC DRIVE PO BOX 5001 VICTORVILLE, CA 92393 Ph: (760) 955-5000

SITE LOCATION 15272 BEAR VALLEY ROAD VICTORVILLE, CA 92395

PARCEL ID: PARCEL: 3093-291-01 PARCEL: 3093-271-07



CITY CASE NO. CITY OF VICTORVILLE ENGINEERING DEPARTMENT

Brian W. Gengler, RCE C44730

DATE

AECOM

DFX4 - Victorville, CA

15272 Bear Valley Road Victorville, CA 92395

CLIENT

CONSULTANT

1255 Broad St. Suite 201 Clifton, NJ 07013, USA 973 883 8500 tel

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WITH THE SOLE EXCEPTION OF THE SENCHMARKS SPECIFICALLY DESCRIBED FOR THIS PROJECT, NO ELEVATION INSTITUTED ON ASSUMED HOMBON IS TO BE USED AS A REFERENCE SECURITION FOR ANY PURPOSE.

REGISTRATION



55	UE/REVISIO	ON .
1	12/01/2020	100% PERMIT SET R1
0	10/13/2020	100% PERMIT SET
I/R	DATE	DESCRIPTION

KEY PLAN

PROJECT NUMBER

60633050

SHEET TITLE

GENERAL NOTES, LEGEND, & ABBREVIATIONS

SHEET NUMBER

C0.01

1994369.019 6763544.955 3112.202

1994302.441 6763627.305 3112.078 1994362.249 6763161.154 3115.100

1995128.959 6763580.027 3105.675

1994588.772 6763186.246 3111.122

10 1994409.173 6763584.223 3110.870

13 1994358,798 6762965,124 3116,796

16 1995498.837 6763019.329 3101.238 17 1995188.248 6762897.444 3101.671

18 1994782,379 6783568,044 3110,279

19 1994723,909 6763262,101 3108,449 20 1995629,891 6763613,548 3098,609

37 1995362,272 6762955,409 3103,797

38 1996280.529 6762946.431 3086.743

41 1936956.800 6763600.144 3081.315

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FND 1" IP LS 3462

FND 2in IRON PIPE - OPEN FND BOAT SPIKE

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NAG NAL

MAG NAL

FND 1" IP

FND BRASS TAG

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4. SURVEY DATES: JUNE 4-7, 2020; AUG 24-27,

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THE CONTRACTOR SHALL GIVE THE CITY OF INCTORVILLE ENGINEERING DEPARTMENT (180) 955-5158 AT LEAST 2 WORKING DAYS NOTICE TO SCHEDULE A PRE-CONSTRUCTION MEETING WITH THE INSPECTOR PRIOR TO STATE OF WITH
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THE CONTRACTORS SHALL BE HELD RESIDURES FOR ANY PILLD OWNERS MADE WITH DRIVEN AMENDATION FROM THE RESIDURE DICHER AND THE CITY OF WITHOUT REPORT OF CONTRACTOR AND THE CITY OF CONTRACTOR SHALL WAS AND THE CITY OF CONTRACTOR AND THE CITY OF CITY
THE CONTRACTOR SHALL BE RESPONSIBLE FOR PROMISING TESTING REQUIRED BY THE CITY'S INSPECTOR AND TRENCH BLOOFFLL COMPACTION TESTING, A CERTIFICATION OF COMPACTION SEARCD BY A REGISTER BEEN SHALL BE SUBMITTED FOR ALL TRENCH BLOCKFLLS. STATIONS SHOWN ON PROOF FARE ON CENTER IN COUNTY IN ESSION FRANCE NO CARTEN.
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ALL SEARLEST O BIE NOTALLED PER CITY STAVONON MARKER SS-MIX.
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PULL BLOSS ADMINIST TO THE CONTROLLES SHALL SE NO. GE (EXTENDICAS, ALL OTHER PULL BLOSS SHALL BE NO. 6 EXCEPT WHERE SHAWN OTHER THIS CON APPROVED BY THE ENCINER.
THATTER SOLAN, CORDULT SHALL BE SCHEDULE 40 INCLUDING ALL SHEEDS WITHIN CONDICTE STRUCTURES MINIMAN SEE CONDUIT FOR ALL INCH DISCISSINGS SHALL BE 2" INMEDITED MINIMAN CONDUIT SEET ON ALL LUTERALE SHALL BE 2" EMPLETE AN IN MAY SEE CONDUIT FROM EERSTAAN RESH FUTTOWN FOLKS OF A PROPORT OF THE FOLKS SHALL BE 2" EMPLETE AN IN MAY SEE CONDUIT FROM EERSTAAN RESH FUTTOWN FOLKS OF A PROPORT OF THE FOLKS SHALL BE 2" EMPLETE AND IN MAY SEE CONDUIT FROM EERSTAAN RESH FUTTOWN FOLKS OF A PROPORT OF THE FOLKS SHALL BE 2" EMPLETE AND IN TH
AL SOME FACES SHALL BY MEANING THE MONORDINGH HERLICOWERD BACK PLATES MYDTHING INDEX. NEL VERICLAR MONEATORS SHALL BE 22°GE. LED. UND OF BACH COLOR AND THE OF SOME INDEXEDDRESHOWN ON THE SHEET.
AL LUMINAN RES SHALL BELLE DL LEGORECH OR PREAPPROVED EQUAL
HE ACCEPTION SHAME SYSTEM SHAME OF T MINISTRON SYSTEM OF POLICIAE DIRECTIONS OF THE THIO MAPE SYSTEM OF BOARTO COMMONS ON AS CHECKED BY THE EMBASER. LL MANYS SHALL HAVE A SEMANTE PROSTROM PLUE BUTTON FOLE PER DIRECTION AS CETALED IN STANDARD PROMINING SLIB.
AL CONDUITS SHALL BE PLACED UNDER DENTING PAYEMENT BY "LACKING AND DIFLLING" WITH A WINNALIN COVER OF 95", OR AS ORECTED BY THE ENDINGER
FECONDACION SHULL PRIVAR- NO RISTAL COMOCTOS AND CARES AS TOPPORTE THE RITINECO SPAN, OPERATOR VIOLENTA METO, OPERATOR CARES, VEZO CARES, SPECIO CARES, SPAN UN HITMAN SPAN E WAYE, SPECIM SPECIAL SPAN E CONTROLLE FOR AND THE CONTROLLE FOR AND
TO DISTRICTION SHALL HAVE FORMER AND TODIS CALLES FOR LACE COMPRIANT IN THE MANUACTIFER. NEIGO EXECUTION SHALL PROVIDE, ON BLUMSMARED TO PROVIDE EXECUTE DETECTION, AND INVESTED COMPRISED ON THE CASE SERVICE OF THE COMPRISED OF THE CASE SERVICE OF THE COMPRISED OF THE CASE SERVICE OF TH
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IL NEW SPANNING DISTRIBUCTORS MUST HAVE A BATTERY MICELP SISTEM INSTALLED FIR CITY OF INTERMALES.
OURL SHID INTERNALD BLUMMARE SPRET (SKENAME SPRESALL BE LEE, THE "A" AND SHALL SE MONTROOM A SEPARATE MAST AAM, INSTALLATION AND PANEL LESPING SHALL BE HIS THE CITY OF INCOMPLIES STANDARDS. ONTRACOGUSHALL MANNERS INDIRNAL SHAM, OFFENDER SET HIS HOURS OF SAME ORD SHALL SHAMED BY THE ENGINEER.
CHIRDLAND REAL WATER AND WATER AND ADDRESS OF CHIRD AND ADDRESS OF AN ARRANGE AND ADDRESS, OR A THE CRIMINATION OF THE CHIRD AND ADDRESS OF CHIRD AND ADDRESS OF AN ARRANGE OF ANY SOCIAL THING OR, ON THE THING A SIGNAL WHITE ADDRESS OF ADDRESS AND OR SHALL BE A MINISTER OF A HINDER AND ADDRESS OF ADDRESS AND ADDRESS OF ADDRESS OF ADDRESS AND ADDRESS OF ADDRESS AND ADDRESS OF ADDRESS AND ADDRESS OF ADDRESS AND AD
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DAT OWNER, SMALE NAUGE.

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FEMALE SMALL, SE SECTION AS REQUISION OF CONTROL OF DIVING CONSTRUCTION. TO PREVENT IMPROVIDE SHEW IN A SECTION OF THE MADE THE WAS TO A SECTION OF THE MADE THE WAS THE WAS TO A SECTION OF THE MADE THE WAS THE W

CLEAR ALL CUT AND FILL AREAS OF VEGETATION AND ORGANIS MATERIALS TO A DEPTH OF BY 16 BY ONES OR MORE.

FILL SHALL BE PLACED IN LIFTS OF EISHT 18) NORES OR LESS AND SUPFICIENT MOISTURE ADDED AND MATERIAL COMPACTED TO ACHIEVE THE REQUIRED PERCENT OF COMPACTION.

CITY OF WICTORVILLE GRADING IMPROVEMENTS GENERAL NOTES

NO GRADING SHALL COMMENCE PRIOR TO 7:00 A.M. EACH WORKING DAY. DUST CONTROL SHALL INCLUDE:

ROSEON CONTROL PLAN GENERAL NOTES 1. ALL-CHART FOR EXECUTION TO A PROPERTY OF THE PROPERTY OF TH LIDITES EMPLOYS TRACTION OF TRACTION (TELES) WERE VANISH MEMBERS.

CHAZES SHALL ON SERVICION OF TRACTION OF THE CETA PLANT OF THE CHAZES SHALL ON SERVICION OF THE CHAZES SHALL OF THE CHAZ THE CONTRICTOR SHULLER REPORMENT AND SHULL THAN SECRETARY PRECURSION FOR MEMORY AND THE PROPERTY AND THE PRO TO CONTROL OF A CONTROL OF THE PROPERTY OF THE ADMINISTRATION OF THE PROPERTY NOW PROGRAMMENT REPORT OF THE PROGRAMMENT OF THE PR THE CALL PROPERTY OF THE SECRET OF THE TOT OF THE SECRET O TOP OF CUTOFF BROW DITCHES, WHERE REQUIRED ON THE PLANS, SHALL BE CONSTRUCTED PRIOR TO EXCEEDING TWELVE FEET (12) OF CUT, MEASURED VERTICALLY, CLUMBO AND CAUGINGS SHALL BE LIMITED TO AREAS THAT MILL RECEIVE INVESTIG GRADING, PROSIDING CONTROL MEASURES AND BE REQUIRED OF PROTICE! AREAS MACH HAVE BEEN CLUMPED AND CRUSSED FOR COSTAGE PERSON, THOSE MASSIVES MAY HALLDE, BUT NOT BE LIMITED TO, GRADED OFFICE'S, BRUSH BARRIERS AND BLT. SEX CANSISHALE BEINGREDOFFOR THE CHARGE MASSIVES MAY HALLDE, BUT NOT BE LIMITED TO, GRADED OFFICE'S, BRUSH BARRIERS AND BLT. SEX CANSISHALE BEINGREDOFFOR THE PROSIDE PROTICES THAT SHARP AND BLT. SEX CANSISHALE BEINGREDOFFOR THE PROSIDE PROSIDED THAT SHARP AND BLT. SHARP A

FORCE ONE SHALL BE DESCRICT ON PRESENT VICE THE PRIVATE OF DESCRICT AND A THE CONTROL STREET AND A THE CONTROL STREET AND A THE CONTROL STREET AND A THE ACCT IN AREA OF ACTIVE CONTROL STREET AND A THE ACCT IN AREA OF ACTIVE CONTROL STREET AND A THE ACCT IN A THE CONTROL STREET AND A THE ACCT IN A A THE 8. PROVIDE EROSION CONTROL ON INCINIOUAL LOTS AND IN THE PARKWAY AND CONTINUOUS PLACEMENT OF SANDBAGS ALONG THE TOP OF THE CURS.

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CITY OF VICTORVILLE STREET IMPROVEMENTS GENERAL NOTES (WHEN AND WHERE APPLICABLE)

1. THESE IMPROVEMENT PLANS ARE BASED ON CITY OF VICTORNILLE BENCH WARK V-INSERT MUMBER, BEING A MISERT PHYSICAL DESCRIPTION, LOCATED AT INSERT LOCATION, HAVING AN ELEVATION OF MISERT PLANS TOWN SPONDED TY ADDITION.

WHERE AN ONSITE CONSTRUCTION BENCH MARK IS ALSO USED, ADD SIMLAR DATA.

2. UNLESS OTHERAISE NOTED, ALL CONSTRUCTION AND MATERIALS SHALL CONFORM TO THESE PLAYS, PROVISIONS OF THE LATEST REVISION OF THE CITY OF VICTORVALLE STANDARD SPECIFICATIONS FOR PUBLIC WORKS CONSTRUCTION, AND PUBLICES AND APPLICABLE PROVISIONS OF THE CITY OF VICTORVALLE ENGINEERING DEPARTMENT.

3. CONTRACTOR AGREES THAT HE SHALL ASSUME SOLE AND COMPLETE RESPONSIBILITY FOR JOB SITE CONDITIONS DURING THE COURSE OF CONSTRUCTION OF THIS PROJECT INCLUDING SAFETY OF ALL PERSONS AN PROPERTY, THAT THIS REQUIREMENT SHALL APPLY CONTINUALLY AND NOT BELIMTED TO NORMAL WORKING HOURS, AND THAT THE CONTRACTOR SHALL DEPEND, INDEMNITY AND HOLD THE OWNER, THE ENGINEER AND THE CITY HARMLESS FROM ANY AND ALL LIBELTY, REAL OR ALLEGED, IN CONNECTION WITH THE PERFORMANCE OF WORK ON THIS PROJECT.

4, IT SHALL BE THE CONTRACTOR'S RESPONSIBILITY TO OBTAIN ANY PERMITS REQUIRED BY THE CITY OF VICTORVILLE ENGINEERING DEPARTMENT IN GROER TO DO THE WORK SHOWN ON THESE PLANS

5. THE CONTRACTOR SHALL GIVE THE CITY OF VICTORVALUE ENGINEERING DEPARTMENT (760) 655-156 AT LEAST 2 WORKING DAYS NOTICE TO SCHEDULE A PRE-CONSTRUCTION MEETING WITH THE INSPECTOR PRIOR TO

A THE CONTRACTOR SHALL NOTIFY THE CITY OF INCTORNALE ENGAGERING DEPARTMENT AT LEAST I WORKING DAY PRICE TO INCRESSARY MERCECTORS AT JUDI (965-198, A REASPECTION FEE WILL SE REPOSEDED ON EACH OCCASION WHEN THE CONTRACTOR IS NOT READY FOR THE INSPECTION AT THE SCHEDULED THIE, NO PURPHER INSPECTIONS WILL SE PERFORMED UNTIL SAMPRE-MARPESTION FEE IS PUID.

7. THE CONTRACTOR SHALL MOTIFY INDESCRIPTION SERVICE II ERT 2 WORKING DAYS IN ADVANCE OF EXCAUATION AT 1,505,423,413,509 EVACT LITHTY LOCATIONS.

6. IT SHALL BE THE CONTRACTOR'S RESPONSIBILITY TO FAMILIARIZE HIMMER SELF WITH SITE CONDITIONS AND OF ANY UNDERGROUND UTILITIES SHOWN OR NOT SHOWN ON THESE PLANS.

8. EXISTING UTILITIES SHALL BE MAINTAINED IN OPERATION DURING CONSTRUCTION.

(OUL PRELIVES, SUBSTRUCTURES, OR UTILITIES OF ANY KIND, WHETHER SHOWN ON THESE PLANS OR NOT, SHALL BE PROTECTED IN PLACE OR, IF REQUIRED, BE REMOVED, RELICATED, OR REINFORCED TO THE
SATISFACTION OF THE CITY ENGINEER AND THE COMPARY CHANNO THE FACILITY AT THE EXPENSE OF THE CONTRACTOR

11, AVI RELOCATION OF EXISTING MAIL BOXES, POWER POLES, STREET LIGHTS, FIRE HYDRAVITS, SIGN POSTS, TELEPHONE PEDESTALS, ETC., SHALL BE RELOCATED OR REMOVED AND REINSTALLED BY AND AT THE EXPENSE OF THE CONTRACTOR.

12.11 SHALL BE THE CONTRACTOR'S RESPONSIBILITY TO PROTECT SURVEYING MONAURINTS IN PLACE AND THE CONTRACTOR SHALL BE HIMMCRALLY RESPONSIBLE FOR RESETTING DAMAGED OR DESTROYED MAY MEDITS.

13 JOSHUA TREES SHALL BE PROTECTED IN PLACE OR RELOCATED AS APPROVED BY THE PARKS DIVISION OF THE CITY OF VICTORALL REPROTECTED IN PLACE OR RELOCATED AS APPROVED BY THE PARKS DIVISION OF THE CITY OF VICTORALL REPROTECTED IN PLACE OR RELOCATED AS APPROVED BY THE PARKS DIVISION OF THE CITY OF VICTORALL REPROTECTED IN PLACE OR RELOCATED AS APPROVED BY THE PARKS DIVISION OF THE CITY OF VICTORALL REPROTECTED IN PLACE OR RELOCATED AS APPROVED BY THE PARKS DIVISION OF THE CITY OF VICTORALL REPROTECTED IN PLACE OR RELOCATED AS APPROVED BY THE PARKS DIVISION OF THE CITY OF VICTORALL REPROTECTED IN PLACE OR RELOCATED AS APPROVED BY THE PARKS DIVISION OF THE CITY OF VICTORALL REPROTECTED AND APPROVED BY THE PARKS DIVISION OF THE CITY OF VICTORALL REPROTECTED AND APPROVED BY THE PARKS DIVISION OF THE CITY OF VICTORALL REPROTECTED AND APPROVED BY THE PARKS DIVISION OF THE CITY OF VICTORALL REPROTECTED AND APPROVED BY THE PARKS DIVISION OF THE CITY OF VICTORALL REPROTECTED AND APPROVED BY THE PARKS DIVISION OF THE CITY OF VICTORALL REPROTECTED BY THE PARKS DIVISION OF THE CITY OF VICTORALL REPROTECTED BY THE PARKS DIVISION OF THE CITY OF VICTORALL REPROTECTED BY THE PARKS DIVISION OF THE CITY OF VICTORALL REPROTECTED BY THE PARKS DIVISION OF THE CITY OF VICTORALL REPROTECTED BY THE PARKS DIVISION OF THE CITY OF VICTORAL REPROTECTED BY THE PARKS DIVISION OF THE CITY OF VICTORAL REPROTECTED BY THE PARKS DIVISION OF THE CITY OF VICTORAL REPROTECTED BY THE PARKS DIVISION OF THE PARKS DIVIS

ILADEQUATE STAKES, AS DETERMINED BY THE CITY ENGINEER, ENABLING THE CONTRACTOR TO CONSTRUCT THE WORK TO PLAN AND GRADE SHALL BE SET BY THE DIRECTION OF THE CONTRACTOR'S LICENSED ENGINEER OR SURVEYOR.

15 THE CONTRACTOR SHALL BE HELD RESPONSIBLE FOR ANY FIELD CHANGES MADE WITHOUT PRIOR WRITTEN AUTHORIZATION FROM THE DESIGNING ENGINEER AND THE CITY OF VICTOR

16.CONTRACTOR WIJL BE SUPPLIED WITH ONE (1) SET OF CONTRACT DRAWINGS TO BE USED FOR AS-BUILT DRAWINGS. THE CONTRACTOR SHALL HAVE THE AS-BUILT DRAWINGS DAILY. THE CONTRACTOR SHALL HAVE THE AS-BUILT DRAWINGS AVAILABLE TO THE OWNER ENGINEER OR INSPECTOR UPON REQUEST, THE AS-BUILT DRAWINGS SHALL INCLUDE THE STATIONS OF ALL CONNECTIONS, TEES, AND LATERALS.

17. ALL EXCAVATIONS SHALL BE BACKFILLED AT THE END OF EACH WORKING DAY AND ROADS MADE SAFE AND OPEN TO VEHICULAR TRAFFIC.

IS THE CONTRACTOR SHALL BE RESPONSIBLE FOR PROVIDING TESTING REQUIRED BY THE CITY'S INSPECTOR AND THE CITY OF VICTORVILLE STANDARD FOR PUBLIC WORKS IMPROVEMENTS, A CERTIFICATION OF COMPACTION 6100ED BY A REQUIRERD ENGINEER SHALL BE SUBMITTED FOR ALL TRENCH BOOKFLIS.

SWIMENROUGH GRUNNG HAS BERNACOUPL LISHED. SIGS, I TESTS SHALL BE TIMEN PER THE STANDAYO SPECIFICATIONS FOR FULL (LIMPROCEURITS OF THE CITY OF INCTOMILLE). FEMSE IS NECESSARY THE THEORYSS SHALL BE CETERARIED AND THE ORDINAL OF THE STANDAY THE ORDINAL OF THE ORDINAL ORDINAL OF THE ORDINAL MAY BE USED FOR BASE.

20. MAXIMUM DRIVEWAY WIDTHS ARE 12 FOR A SINGLE CAR GARAGE, 16 FOR A TWO CAR GARAGE AND 24 FOR A 3 CAR GARAGE. DRIVENAY SHALL ALIGN WITH GARAGE DOORS) OR CARPORT AND SE PERPENDICULAR TO CURR.

21 F MPROVEMENTS OF ASPHALT OR PORTLAND CEMENT IS TO BE PLACED DIRECTLY ON SUBSURFACE, A SQL STERFLANT REGISTERED BY THE EPA FOR USE LINDER ASPHALT OR PORTLAND CEMENT SHALL BE LINFORMLY APPLIED PER MANUFACTURER'S RECOMMENCED PATE FOR THE ENTINE SURFACE IN CONTACT WITH THE SUBSURFACE (PLUL PAVEMENT WIDTH) PRIOR TO PAVING.

22.ALL NEW AC PAYEMENTS SHALL BE SEAL COATED AS DETERMINED BY THE CITY ENGINEER PER CITY OF VICTORNILLE STANDARD SPECIFICATIONS OR CALIFORNIA DEPARTMENT OF TRANSPORTATION STANDARD SPECIFICATIONS.

22.CONSTRUCTION TRUFFIC CONTROL AND TEMPORARY STRIPNS AND SIGNING PLANS SHALL BE PREPARED BY THE CONTRACTORS ENGINEER AND BE APPROVED BY THE CITY ENGINEER PRIDE TO COMMENCEMENT OF CONSTRUCTION WERE AND CONSTRUCTION WORK ON EXISTING STREETS.

24 JINAL STRIPING AND TRAFFIC CONTROL SIGN PLANS SHALL BE PREPARED BY THE DEVELOPER'S ENGINEER AND BE APPROVED BY THE CITY ENGINEER. STRIPING AND PAVEMENT MARKINGS SHALL BE FURNISHED BY THE CONTRACTOR, ALL STREET MARKNOS, LAVE LINES, LEGENCS, LIMIT LINES, ETC., ON RULL STREET IMPROVEMENTS, SHULL BE THERMOPULATIO ON FINAL CAP, PAINTED STRIPING AND MARKNOS MAY BE PERMITTED IF PREMIOUSLY APPROVED BY THE CITY ENGINEER. ON PARTIAL STREET IMPROVEMENTS THAT ARE NOT COMPLETING THE STREET TO FULL IMPROVEMENTS. 25 STREET NAVE SIGNS AND TRAFFIC CONTROL SIGNS SHALL BE INSTALLED BY THE CITY OF MICTORVALLE AT THE EXPENSE OF THE CONTRACTOR.

20 ALL FIRE HYDRANT LOCATIONS SHALL BE DELINEATED BY A BLUE DOT IN THE PARAMENT LOCATED ON A LINE PERPENDICULAR TO THE CURB AND AT THE CENTER OF THE FIRE HYDRANT APPROXIMATELY IT FROM THE LEFT SIDE OF THE NUMBER 1 LANE (LANE CLOSEST TO THE CENTER LINE) ON THE SIDE OF THE STREET ON WHICH THE FIRE HYDRANT IS LOCATED.

27 THE TOP OF CURB SHALL BE PAINTED RED 15 FEET EITHER SIDE OF A FIRE HYDRANT RED (NO PARKING), THE CURB IN A CURB RETURN OR A DRIVEWAY APPROACH NEED NOT BE PAINTED.

28.THE CONTRACTOR SHALL CLEAN THE STREETS PRIOR TO OCCUPANCY AND SHALL KEEP THE STREETS CLEAN UNTIL THEY ARE ACCEPTED BY THE CITY OF MICTORVILLE.

AECOM

DFX4 - Victorville, CA

15272 Bear Valley Road Victorville, CA 92395

CLIENT

CONSULTANT

1255 Broad St. Suite 201 Clifton, NJ 07013, USA 973 883 8500 tel

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DO NOT SOALE THIS DOCUMENT, ALL MEASURE FROM STATED CAMENSIONS.

WITH THE SOLE EXCEPTION OF THE SENCHARROS SPECIFICALLY DESCRIBED FOR THIS PROJECT, NO ELEWINDON RECEIVED ON ASSUMED HERSON IS TO BE USED AS A REFERENCE SLEWYICH FOR ANY PURPOSE.

REGISTRATION



ISSUE/REVISION

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1	12/01/2020	100% PERMIT SET R1
0	10/13/2020	100% PERMIT SET
I/R	DATE	DESCRIPTION

KEY PLAN



DATE

PROJECT NUMBER 60633050

CITY CASE NO. CITY OF VICTORVILLE ENGINEERING DEPARTMENT

14343 Civic Drive, Victorville, CA 92392 (760) 955-500


Brian W. Gengler, RCE C44730


CITY GENERAL NOTES SHEET NUMBER


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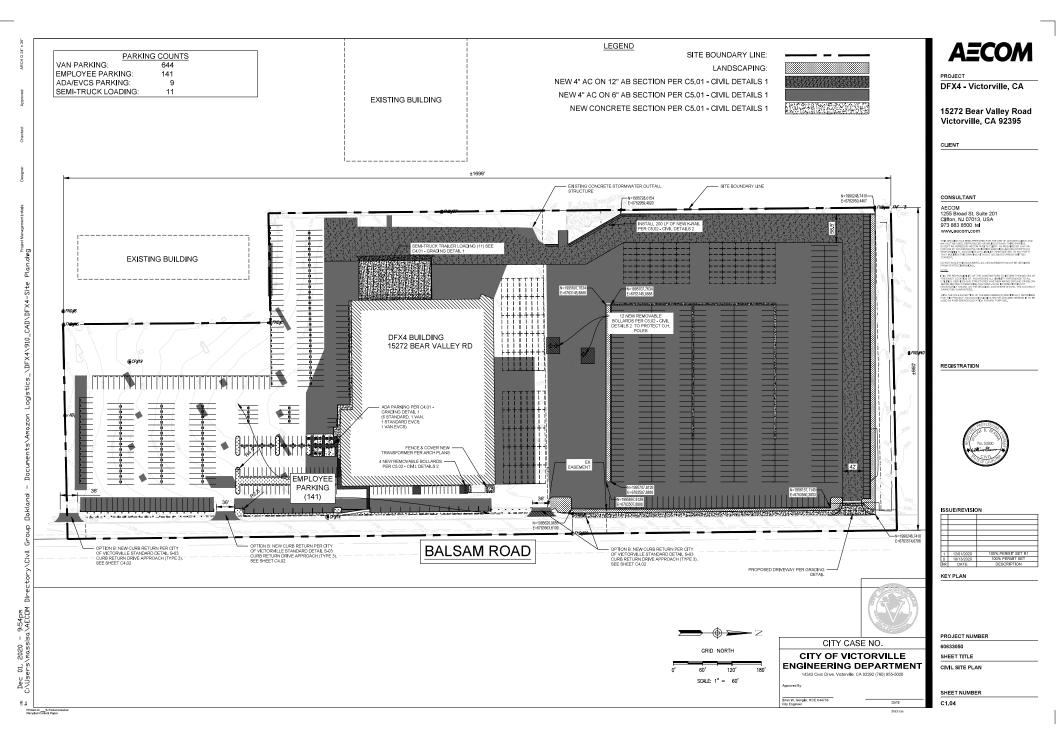
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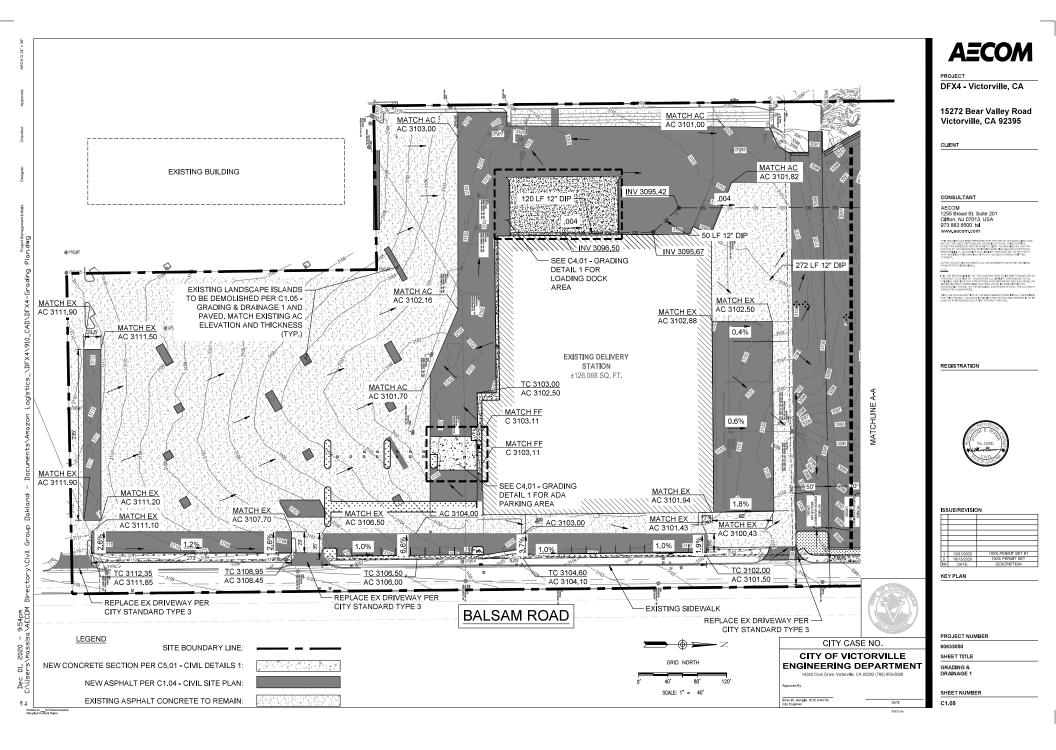
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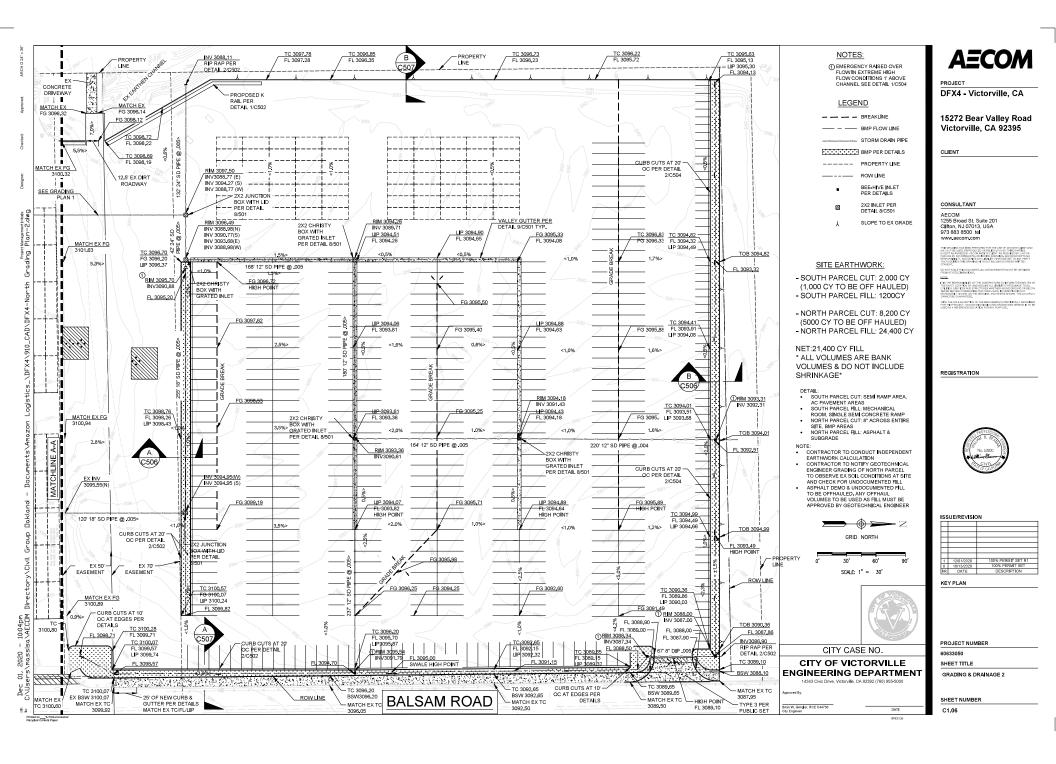








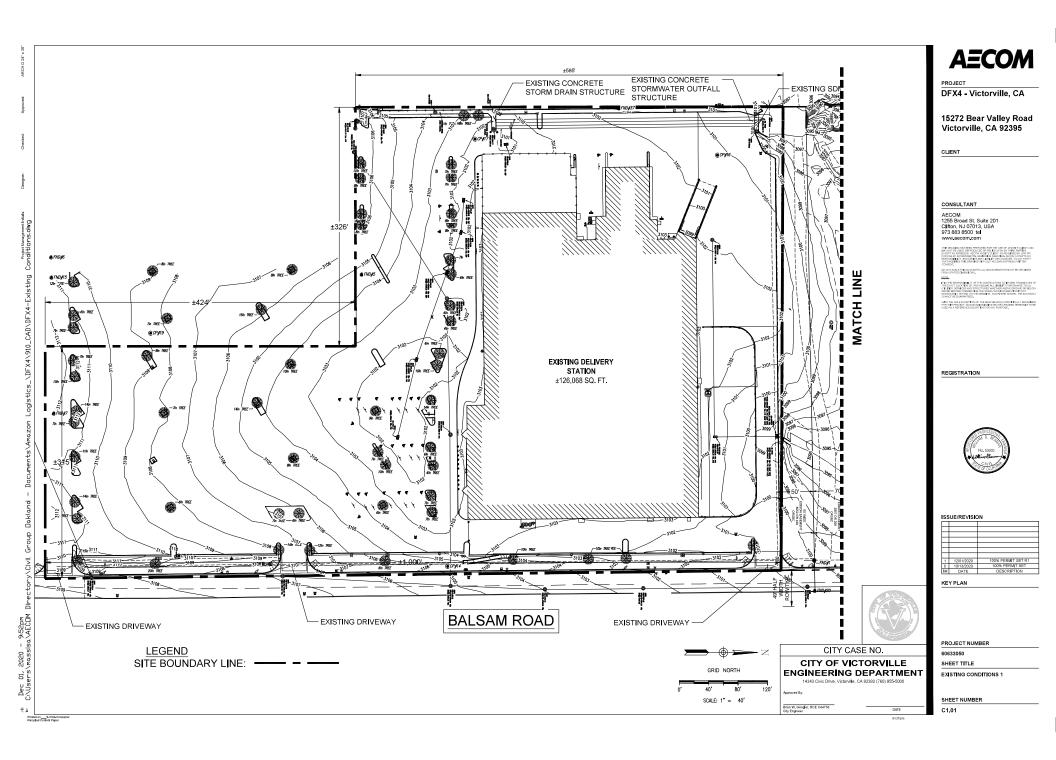


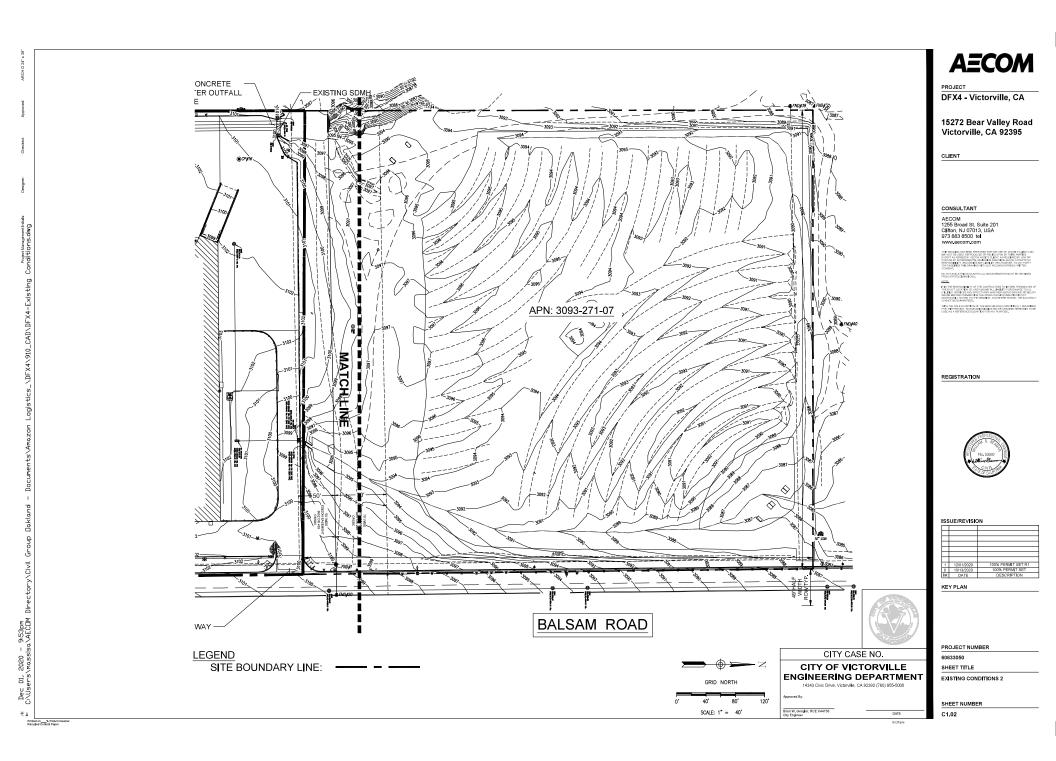

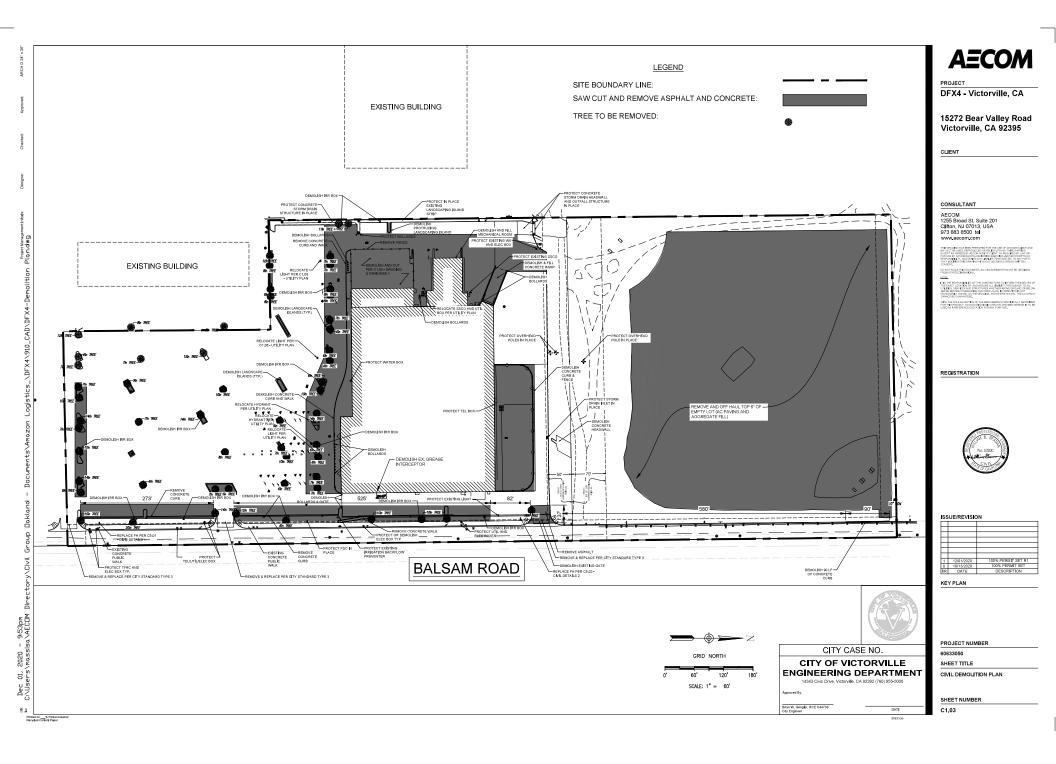

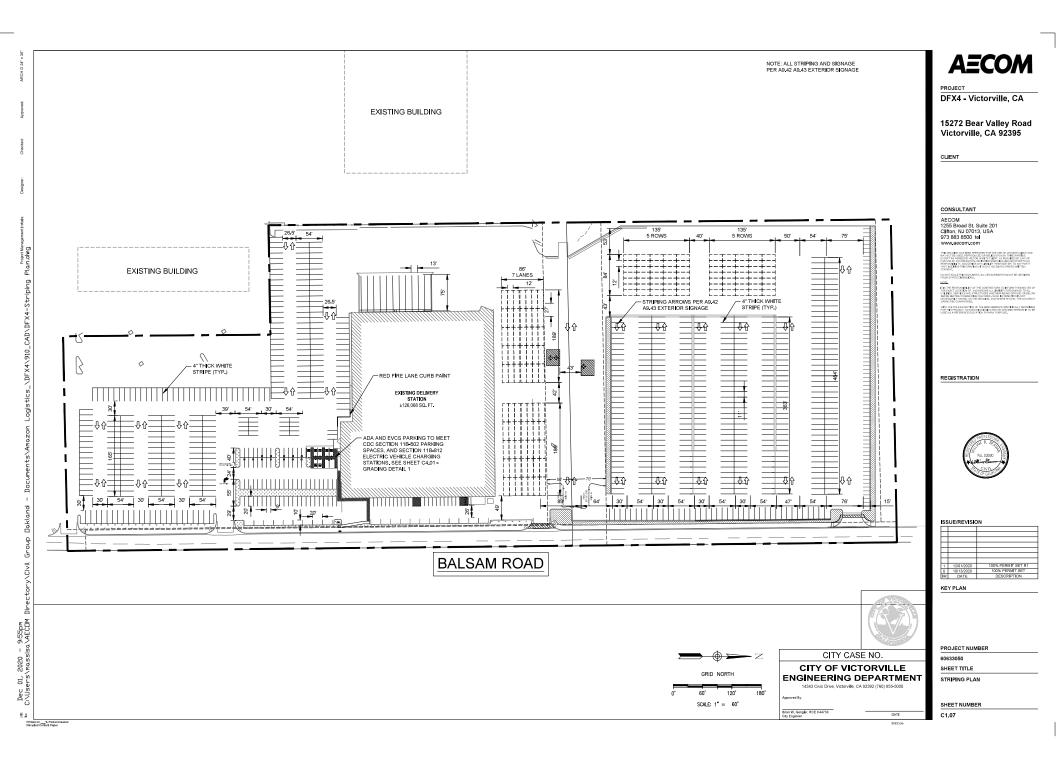


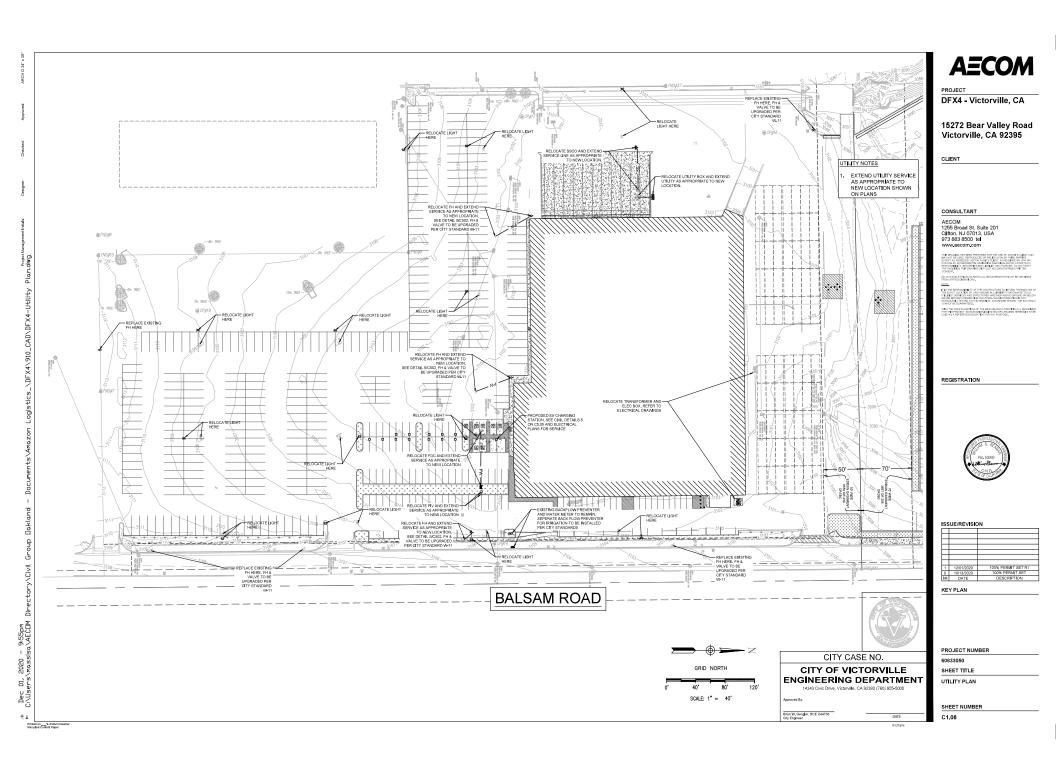

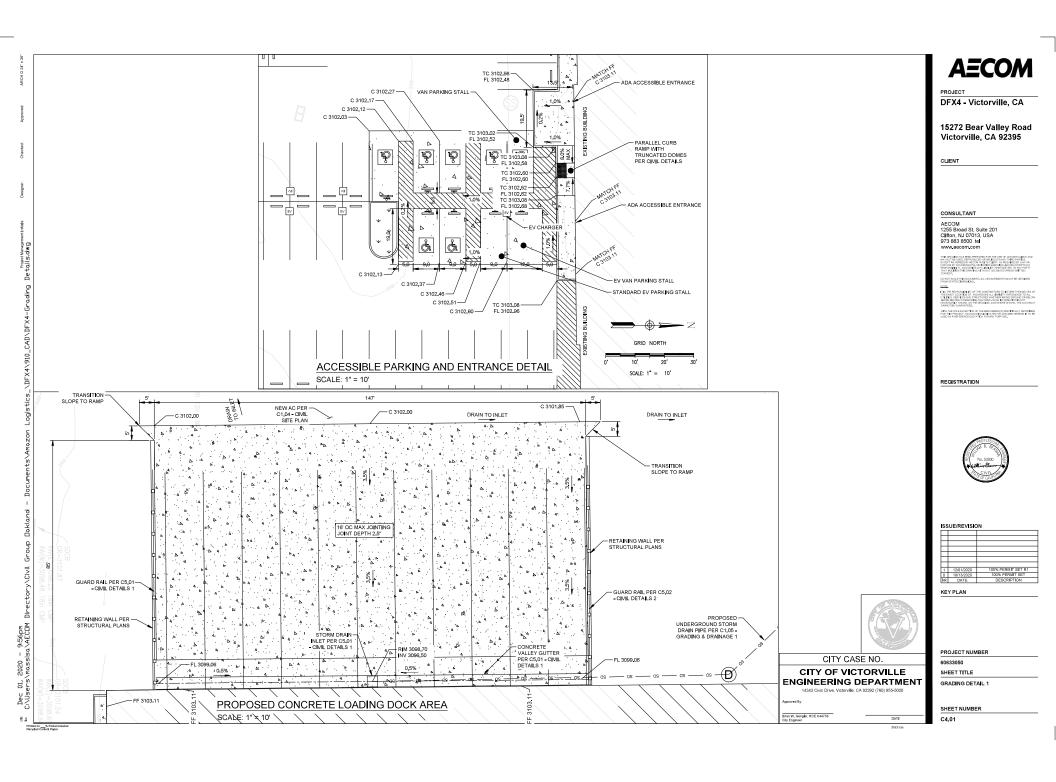

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3. COMMERCIAL DRIVE APPROACH SHALL BE CONSTRUCTED ON MINIMUM 8" CLASS 2

5. EXPANSION JOINTS SHALL BE CONSTRUCTED AT BOTH ENDS OF DRIVEWAY APPROACHES. 6. EXPANSION JOINTS SHALL BE 1/2" WIDE AND FILLED WITH PLASTIC TYPE FILLERS.

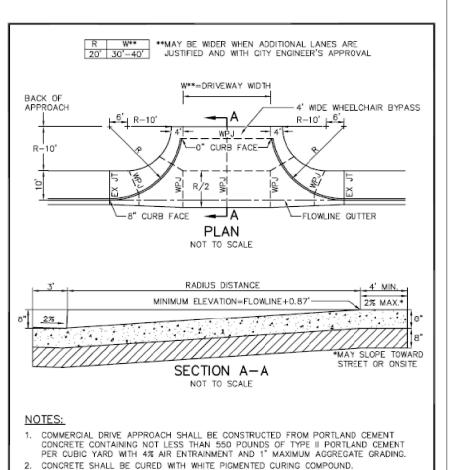CITY OF VICTORVILLE - ENGINEERING DEPARTMENT

CURB RETURN COMMERCIAL

DRIVE APPROACH (TYPE 3)


JOHN A. McGLADE, CITY ENGINEER

S-03

SHEET 3 OF 3

AGGREGATE BASE COMPACTED TO 95% RELATIVE COMPACTION. 4. WEAKENED PLANE JOINTS SHALL BE AT LEAST 2" DEEP.

7. COMMERCIAL DRIVE APPROACH SHALL BE MEDIUM BROOM FINISH.

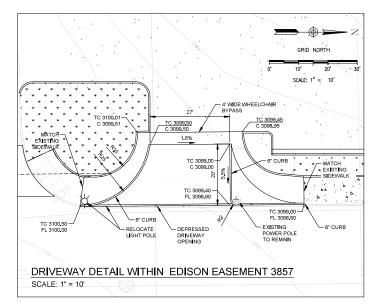

AECOM

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15272 Bear Valley Road Victorville, CA 92395

CLIENT

CONSULTANT

AECOM 1255 Broad St, Suite 201 Clifton, NJ 07013, USA 973 883 8500 tel

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REGISTRATION



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7	12/01/2020	100% PERMIT SET R1
0	10/13/2020	100% PERMIT SET
/R	DATE	DESCRIPTION

KEY PLAN

ISSUE/REVISION



SHEET TITLE

GRADING DETAIL 2

SHEET NUMBER

C4.02

CITY CASE NO.

CITY OF VICTORVILLE **ENGINEERING DEPARTMENT**

14343 Civic Drive, Victorville, CA 92392 (760) 955-5000

REV.


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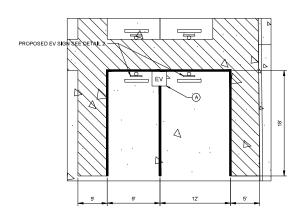
2/12/93

6/1/07 STAFF

BY

D.G.H.




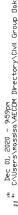


GROUND LEVEL EV CHARGING STATION
SCALE: 1"=5"

PLAN NOTES:

- 1. EV PARKING AS SHOWN ON PLANS.
- EXISTING SLOPE OF EV PARKING STALLS IS MAXIMUM 2% SLOPE AND CROSS.

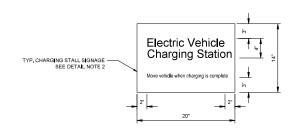


2 ELECTRIC VEHICLE SIGN SCALE: NTS

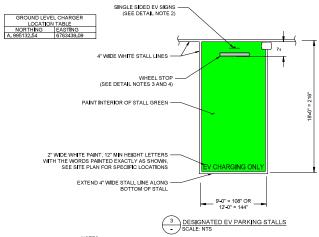


NOTES:

- THE ACCESSIBLE EV SPACE, PATH AND ACCESSIBLE CHARGING STATION EQUIPMENT SHALL MEET ALL APPLICABLE PROVISIONS AS SET FORTH IN THE CURRENT EDITION OF THE CALIFORNIA BUILDING CODE (CBC) ACCESSIBILITY REQUIREMENTS.
- 2. SIGNS TO CONFORM TO CURRENT STATE AND LOCAL REGULATIONS.
- 3. 4-FT LONG, 6-IN WIDE WHEEL STOP TO BE ANCHORED TO PAVEMENT.
- 4. ALL WHEEL STOPS SHALL COME WITH 2 STANDARD DIAMETER PREDRILLED HOLES.

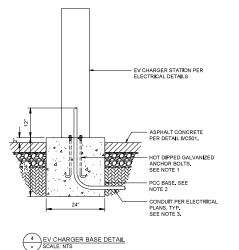

- J-BOLTS MUST EXTEND AT LEAST 2 ½" ABOVE CONCRETE AND 9" BELOW CONCRETE
- 2. CONCRETE BLOCK SHOULD EXTEND NO MORE THAN 2" ABOVE GRADE.
- 3. CONDUIT MUST EXTEND 12-24" ABOVE

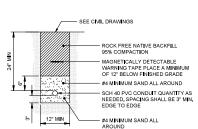





CITY OF VICTORVILLE **ENGINEERING DEPARTMENT**

Brian W. Gengler, RCE C44730 DATE

AECOM

DFX4 - Victorville, CA

15272 Bear Valley Road Victorville, CA 92395

CLIENT

CONSULTANT

AECOM 1255 Broad St, Suite 201 Clifton, NJ 07013, USA 973 883 8500 tel

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REGISTRATION



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KEY PLAN


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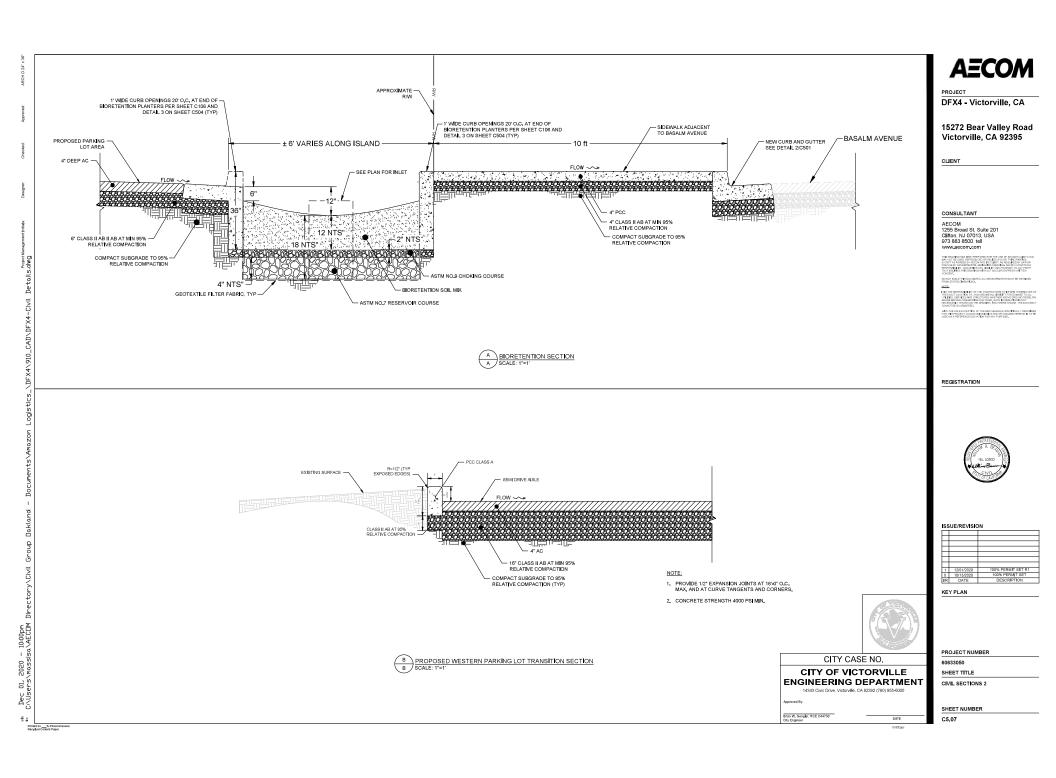
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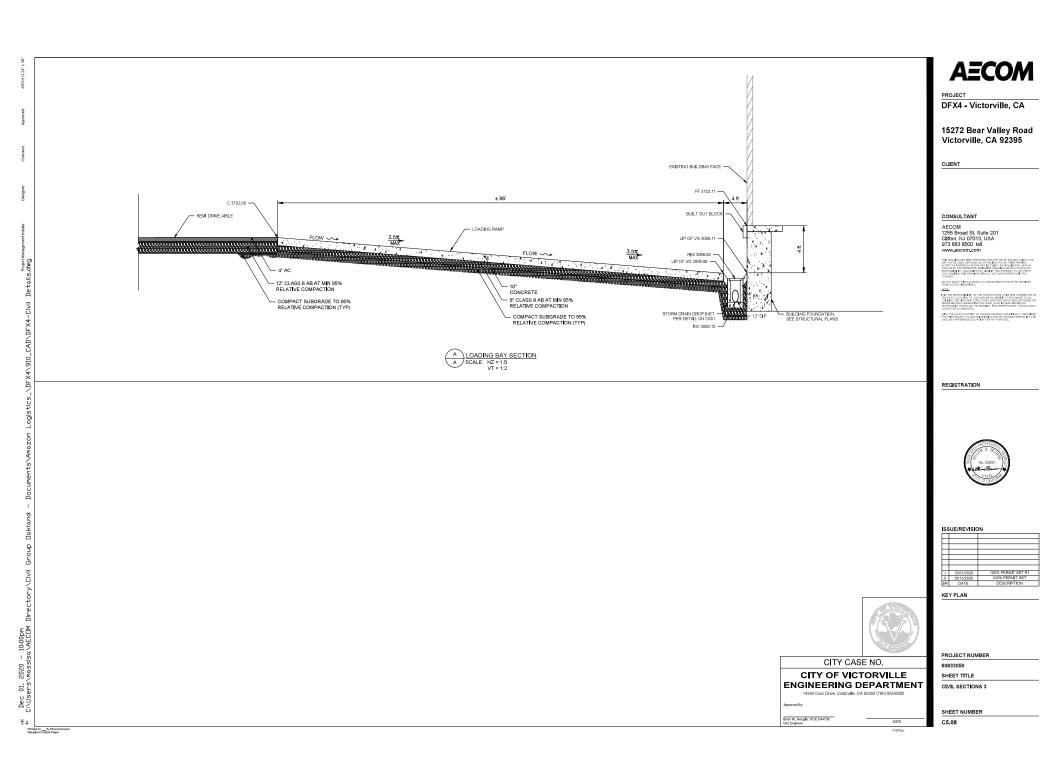
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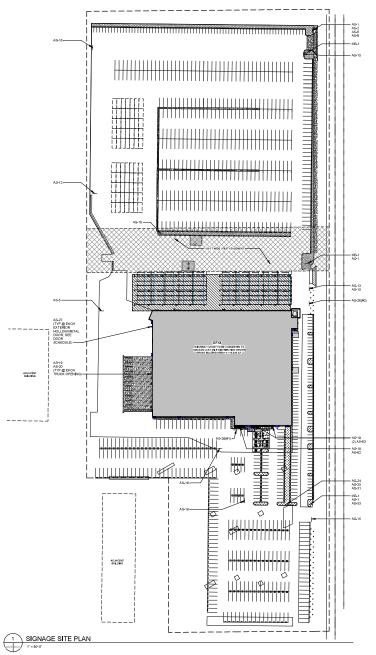
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GENERAL NOTES - SITE SIGNAGE

- FINAL SIGN QUANTITIES SHALL BE COORDINATED AND VERIFIED IN THE FIELD.

- One-device sortion. ALL Involved of advantage about the involved in the involved and involved in the involved and involved involved in the involved and involved in the involved in the involved involved in the involved involved in the involved involved involved in the involved involved involved involved in the involved involved in the involved involved involved involved in the involved involved involved involved involved involved in the involved i

SIGNAGE LEGEND DIRECTION OF SIGN FACE - INDICATES ARROW DIRECTION, IF APPLICABLE — SIGN NUMBER (PER LEGENDS) SIGN TYPE (S-SIGN, AS-TENANT SIGN, PG-PAVEMENT GRAPHIC)

TENANT SIGN FACE LEGEND

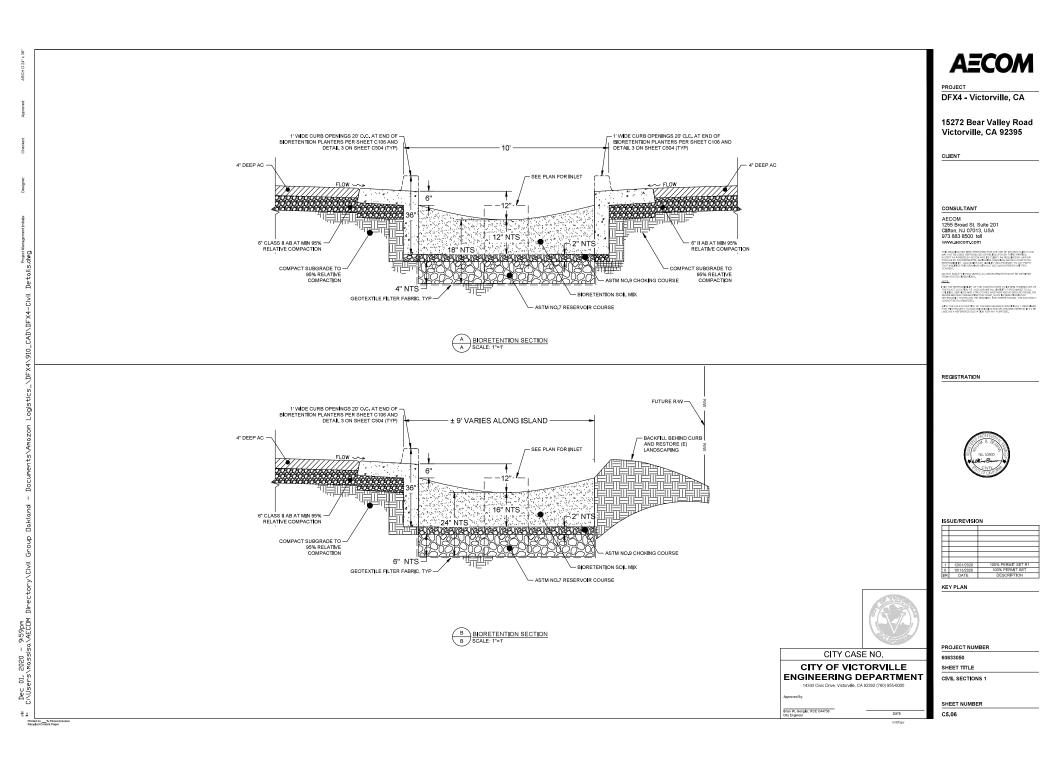I ENANT:	SIGN FACE LEGEND
AS-1	ADDRESS SIGN
A9-2	TRUCKS/VISITOR USHER
AS-5	YARD RULES
AS-6	TRUCK ENTRANCE
A5-7	DRÍVER'S LOUNGE
AS-8	RECEIVING DRIVER ENTRANCE
AS-9	SHIPPING DRIVER ENTRANCE
AS-10	TRACTOR PARKING
AS-12	TRAILERS MUST BE 3FT FROM WALL
AS-13	NO ENTRANCE
A5-14	NO EXIT
AS-15	EXIT
AS-16	WAYFINDING
AS-17	DROP-OFFIPICK-UP AREA, STRAIGHT ARROW
AS-17(L)	DROP-OFFIPICK-UP AREA, LEFT ARROW
AS-17(R)	DROP-OFFIPICK-UP AREA, RIGHT ARROW
AS-20	DOCK NUMBERS
AS-22	DROP-OFF AND PICK-UP
AS-23	ASSOCIATE OF THE MONTH
AS-24	VISITOR PARKING
AS-25	VENDOR PARKING
AS-28	MUSTER AREA
AS-29	MOTORCYCLE PARKING
AS-30	NON-SMOKING AREA
AS-31	CUSTOMER PARKING

AS-C# PARKING LOCATION (AS-0#, AS-8#, AS-G#, AS-P#, AS-Y# REFER TO DETAILS FOR ADDITIONAL TYPES.

AS-53 WAYFINDING (VISITORS & ASSOCIATES, TRUCKS)

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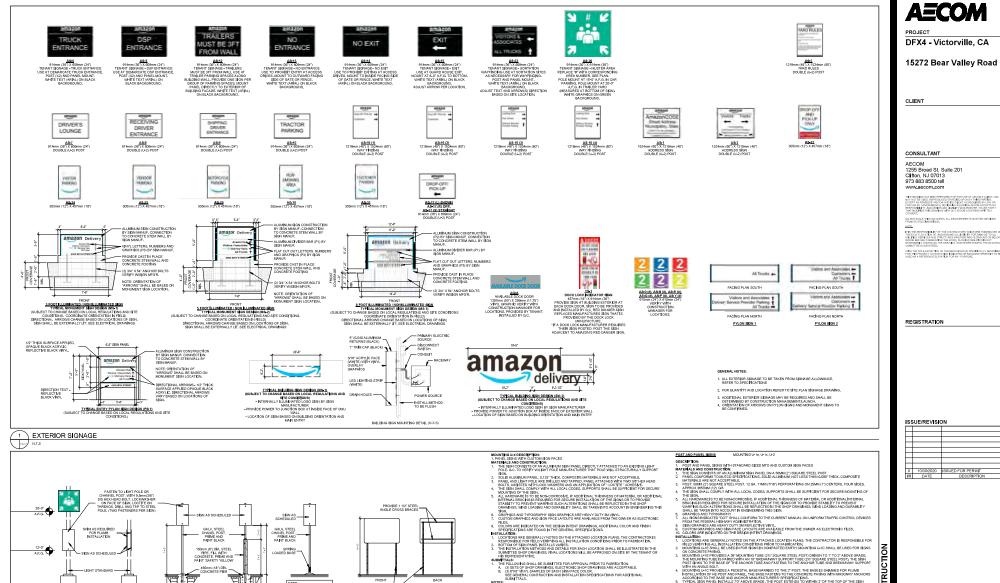
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60633050 SHEET TITLE

SITE SIGNAGE PLAN

SHEET NUMBER

A0.11



NOTES:

1. VERBY POST SEE WITH SISH MOUNTING HEIGHTS.

2. THESE DETAILS PROVIDE INTENT ONLY, FINAL POST & CONNECTIONS SHALL BE SIZED MEETING LOCAL STANDARDS.

PROJECT NUMBER

60633050

EXTERIOR SIGNAGE DETAILS

SHEET NUMBER

A0.13

MOUNTING DETAILS
1:50

SIDE ELEVATION

SIGN AT SITE LIGHT POLE


SIGN IN LANDSCAPED ISLAND

SIGN POST MOUNTED AT

ON CONCRETE BANNIS.

MOUNTHOW LIFE PROVIDES A 38" MOUNTING TUBE (2½" SQUARE STEEL POST) ORIVEN TO 1"TO 2" ABOVE GRADE.
FILE MOUNTING TUBE IS PAIRED WITH AN 18" BREAKAWAY SUPPORT TUBE (2½" SQUARE STEEL POST). THE
ORDS STINKS TO THE BASE OF THE MICHOR TUBE AND FASTENS TO THE AVIORAT TUBE AND BERKAWAY SUPPORT


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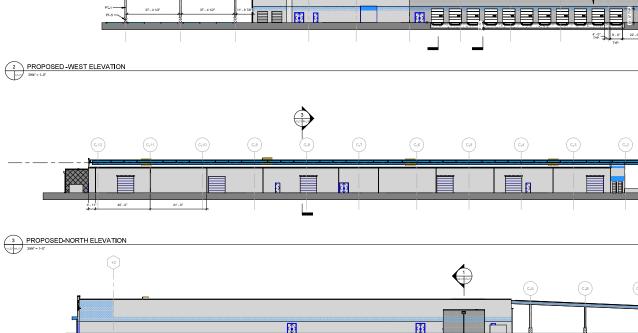

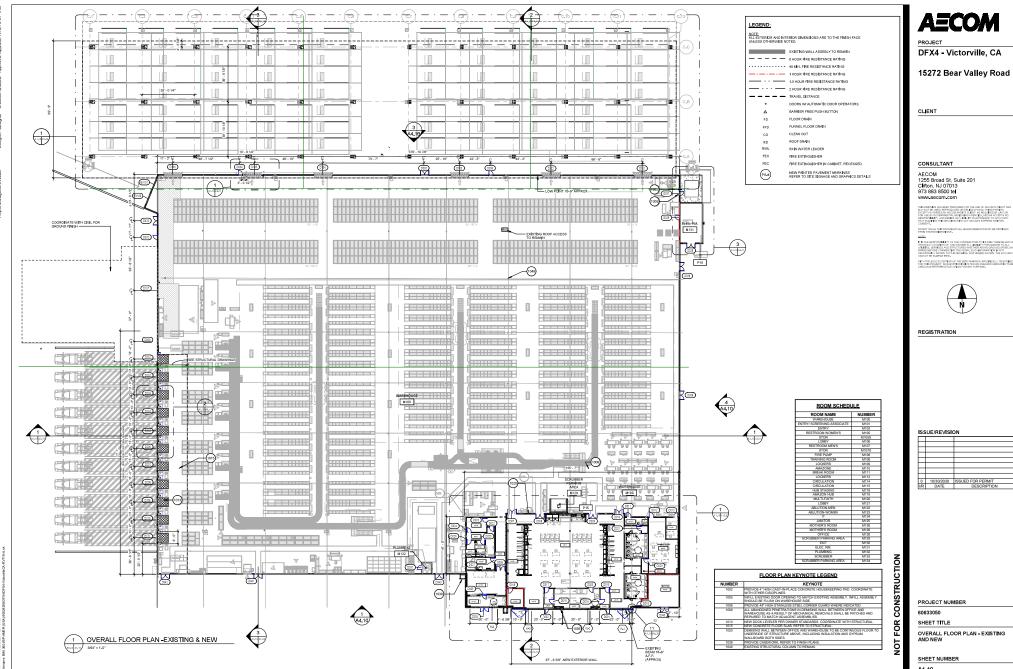
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A1.10





PT-3 4031 PT_3 4030
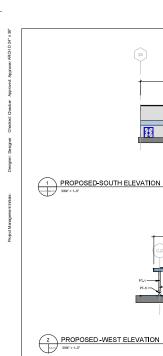
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4032 PT-1

ELEVATION GENERAL NOTES:

- FOR DEMOLITION OR REMOVALS REFER TO DEMOLITION DRAWINGS, UNO.
- WHERE EXISTING EXTERIOR WALL MOUNTED ELECTRICAL FIXTURES ARE TO BE REMOVED AND NOT REPLACED WITH NEW, A FULLY SEALED COVER PLATE PAYMED TO MATCH EXISTING ADJACENT SHALL BE INSTALLED.

- 7. ALL VERTICAL DIMENSIONS ARE FROM FINISHED FLOOR, UNO.
- ALUMINUM DOOR TO MATCH STOREFRONT SYSTEM, TYP SEE DOOR SCHEDULE.
- 10. PAINT ALL SIDES OF SOFFIT PT-3.

- FIRST FLOOR →

- REFER TO ANZL CANOPY DESIGN GUIDELINES FOR ADDITIONAL INFORMATION.
- 12. REFER TO SHEET A0.12 & A0.13 FOR SIGNAGE AND GRAPHICS

ELEVATION KEYNOTE LEGEND							
NUMBER KEYNOTE							
4030 EXISTING SMOOTH FACE CMU WALL TO REMAIN.							
4031	EXISTING SPLIT FACE CM						
4032	PROVIDE SMOOTH FACE	CMU WALL.					
EXTERIO	R COLOR LEGEND						
MARK	DESCRIPTION	REMARKS					
EXTERIOR F	AINT / TEXTURED ACRYL WALLS)	IC COATING					
//	ANODIZED ELUMINUM STOREFRONT SYSTEM	REFER TO WINDOW SCHEDULE					
PT-1	SW 7063 NEBULOUS WHITE	EXTERIOR FIELD COLOR					
PT-2	SW 7066 GRAY MATTERS	EXTERIOR ACCENTCOLOR					
PT-3	AMAZON PRIME BLUE, TO MATCH PANTONE 2995C	EXTERIOR ACCENT COLOR					
PT-4	MANU. STANDARD "BRIGHT WHITE"	EXTERIOR FIELD COLOR					
PT-5	OSHA CAUTION YELLOW/ BLACK	COLUMN BASE AND COLUMN PROTECTION					

MEZZANINE 8-11" FIRST FLOOR T TEMPERED GLAZING PER DESIGN CRITERIA CJ CONTROL JOINT

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DFX4 - Victorville, CA

15272 Bear Valley Road

CLIENT

CONSULTANT

AECOM 1255 Broad St, Suite 201 Clifton, NJ 07013 973 883 8500 tel vww.aecom.com

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REGISTRATION



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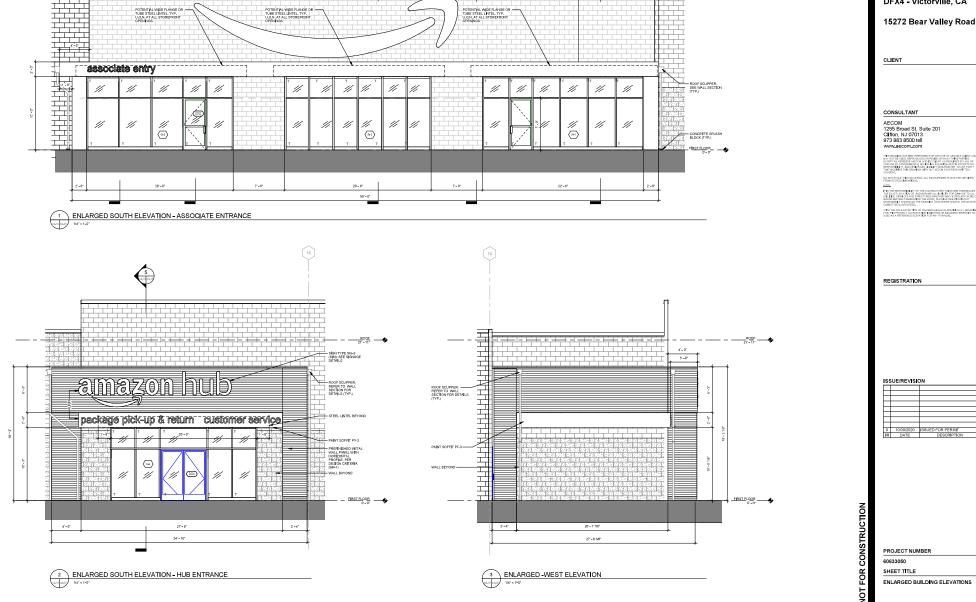
SHEET TITLE BUILDING ELEVATIONS

SHEET NUMBER

A4.10

4 PROPOSED EAST ELEVATION





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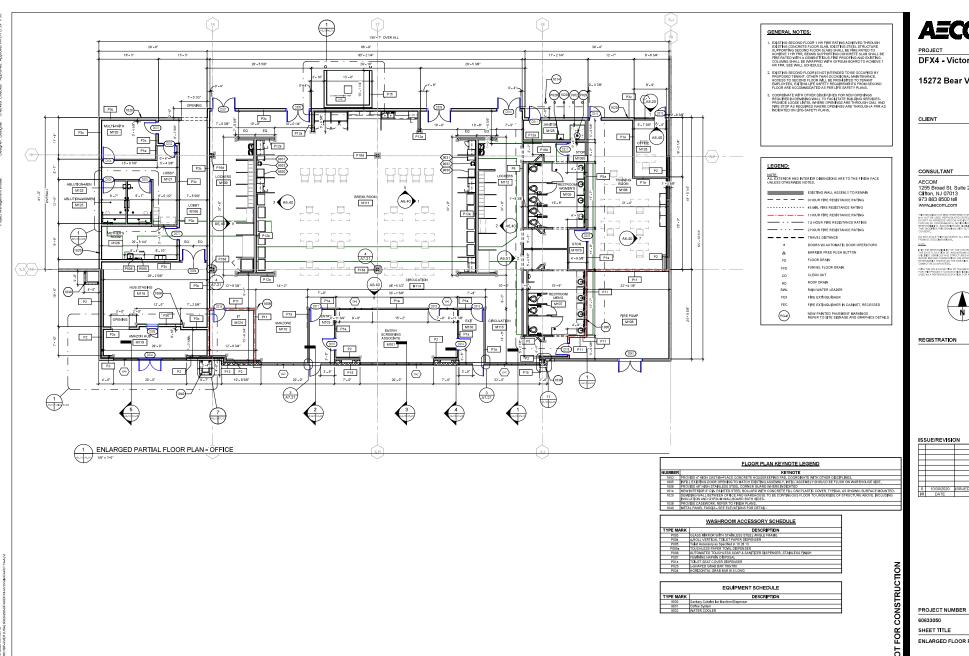
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SHEET NUMBER

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1255 Broad St. Suite 201

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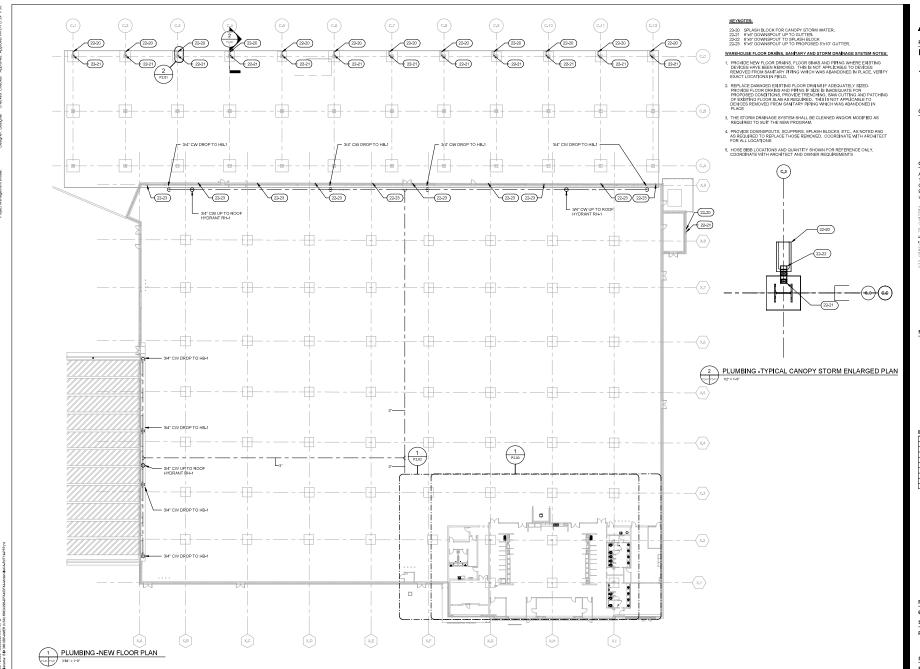


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ENLARGED FLOOR PLANS - OFFICE

SHEET NUMBER

A6.10





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15272 Bear Valley Road

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CONSULTANT

1255 Broad St, Suite 201 Clifton, NJ 07013 973 883 8500 tel

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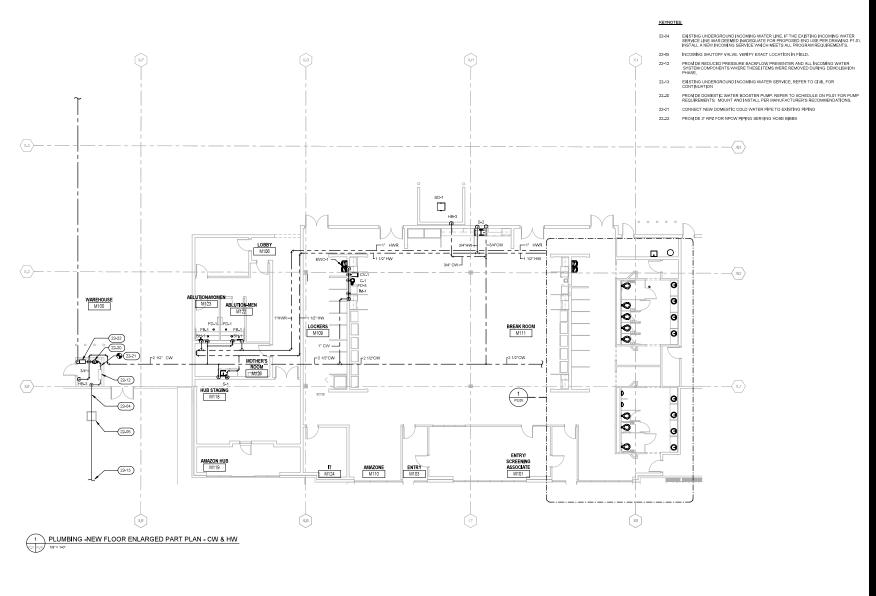
PROJECT NUMBER

60633050

PLUMBING - NEW FLOOR PLAN

SHEET NUMBER





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PROJECT NUMBER

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PLUMBING - NEW FLOOR ENLARGED PART PLAN - CW & HW

SHEET NUMBER

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PLANTING NOTES

PLANTING GENERAL NOTES:

VERHEIED PRIOR TO COMMENCING WORK

2) ALL WORK SHALL RE PERFORMED IN CONFORMANCE WITH APPLICABLE LOCAL CODES

3) CONTRACTOR SHALL BE RESPONSIBLE TO CONSULT WITH OWNER'S REPRESENTATIVE. SITE SUPERINTENDENT, APPROPRIATE AGENCIES AND CONSTRUCTION DOCUMENTATION TO DETERMINE THE LOCATIONS OF ALL EXISTING, PROPOSED AND ARAMOONED UNDERGROUND UTILITIES, PIPES, AND STRUCTURES, CONTRACTOR TO IDENTIFY CONFLICTS WITH THE LANDSCAPE WORK IF THEY EXIST AND BRING TO THE ATTENTION OF AUTHORIZED OWNERS REPRESENTATIVE FOR RESOLUTION.

4) PLANTING OPERATIONS ARE TO BE COORDINATED WITH SEASONAL CONDITIONS. DO NOT INSTALL PLANT MATERIAL IN CONDITIONS WHERE THE SITE IS EXCESSIVELY HOT OR IN FREEZING CONDITIONS.

5) CONTRACTOR IS TO PROTECT ALL DELIVERED PLANT MATERIAL FROM WEATHER CONDITIONS AND OTHER CONSTRUCTION ACTIVITIES.

8) ALL PLANT MINTERAL IS TO BE PLANTED WITHIN 2 WEEKS OF DELIVERY TO SITE. THE STORMER OF PLANT MATERIAL IS TO BE APPROVED BY OWNERS AUTHORISED TO SITE THE STRENGENHARM PERFOR DELIVERY AND STORMER MINTERNAL CONTRICTOR IS TO SUBMIT TO MINTERNANCE, PROTECTION PLAN, AND OTHER MISCHIES THAT ASSESSES THAT PLANT MATERIAL AN STORMER MALE PLEATINF AT THE OF INSTALLATION.

7) Contractor is to submit a schedule of planting operations with identification of submittals, inspections, delivery of plant material and estimated time of maintenance and establishment.

1) PLANT WATERIAL LOCATIONS SHOWN ARE DIAGRAMMATIC AND MAY RE SUBJECT TO CHANGE IN THE FIELD BY THE OWNERS AUTHORIZED REPRESENTATIVE. PLANT LOCATIONS ARE TO BE ADJUSTED IN THE FIELD AS NECESSARY TO SCREEN UTILITIES BUT NOT BLOCK WINDOWS, SIGN NOR IMPEDE ACCESS, UTILITY LOCATIONS

2) PLANT TREES 3'-0" MINIMUM FROM FACE OF CURB AND FROM EDGES OF PAYING. ALL TREES OF UNMERSION INDIA FACE OF CURB AND FROM EDGES OF PAYMO.
ALL TREES WITHIN 5' OF PAYMOG AREAS SHALL HAVE DEEP ROOT BARBERS INSTALLED.
SEE LINEAR ROOT BARRER DETAIL 24" DEPTH. INSTALL PER MANUFACTURER'S
SPECIFICATIONS.

3) IF CONFLICTS ARISE BETWEEN SIZE OF AREAS AND PLANS, CONTRACTOR TO CONTACT LANDSCAPE ARCHITECT FOR RESOLUTION. FAILING TO MAKE SUCH CONFLICTS KNOWN WALL RESULT IN CONTRACTOR'S LIGHLING TO REDUCE SUCH MATERIALS. CONTRACTOR TO YERIFY EXACT QUANTITIES OF PLANT MATERIAL RECESSARY.

4) CONTRACTOR MUST REVIEW ALL PLANS PRIOR TO THE BEGINNING OF CONSTRUCTION AND MAINTAIN THE FOLLOWING CLEARANCE FOR ALL TREE PLANTINGS, NOTIFY LANDSCAPE ARCHITECT OF ANY CONFLICTS.

FIRE HYDRANTS AND PIVS: 3' MINIMUM LICHTPOLES: 10" MINIMUM BUILDINGS: 15' WINIWUM

1) CONTRACTOR TO CONFIRM SOURCE OF TOPSOIL FOR ALL PLANTING BEDS EITHER FROM ACCEPTABLE STOCKPILE, EXISTING GRADE OR IMPORT, ALL SOILS INTENDED TO BE USED ARE TO BE TESTED AND VENIFIED SUITABLE, REFER TO ADDITIONAL REQUIREMENTS AS

2) THE PLANTING AREAS ARE TO BE GRADED IN ACCORDANCE TO CIVIL DRAWINGS AND ALL PLANTING BEDS ARE SLOPED TO DRAIN, NO AREA OF THE PLANTING IS TO BE FLAT AND WILL POND, ALL DRAINAGE SWALES AND STRUCTURES ARE NOT TO BE

3) ALL OVER EXCAVATION REQUIRED TO MEET PLANTING SPECIFICATIONS SHALL BE DONE PRIOR TO PAYING IF PAYING WILL CONFLICT WITH EXCAVATION OF PLANTING PITS A) CRADES SHALL BE APPROVED BY THE CHINER'S REPRESENTATIVE PRIOR TO PLANTING OF PLANT MATERIALS. PERFORM FINE GRADING IN ALL PLANTING AREAS AND COORDINATE FINISH GRADE TO ALLOW MULCH AS INDICATED IN SPECIFICATIONS.

5) PRIOR TO PREPARATION OF THE PLANTING OPERATIONS, ALL PLANTING AREAS TO RECEIVE HERBICIDE TREATMENT OR ACCEPTABLE ORGANIC TREATMENT FOR WEED CONTROL. THE METHOD AND APPLICATION RATES PER REGULATIONS OF FEDERAL STATE.

1) CONTRACTOR IS RESPONSIBLE TO ORDER ADEQUATE QUANTITIES OF PLANT MATERIALS TO FILL PLANTING BEDS IN ACCORDANCE TO DESIGNATED SPACING SHOWN IN

2) ALL REPRESENTATIVE SAMPLES OF PLANT MATERIALS SHALL BE INSPECTED AT THE SITE FOR APPROVAL BY THE OWNER'S REPRESENTATIVE AND MEET THE FOLLOWING STANDARDS:

a) Quality and Size shall conform to the current issue of the american Standard of Mursery Stock published by the american association of Nursertimen

b) use only nursery-grown stock and plant material must be selected from nurseries that have been inspected by state or federal agencies.

c) PLANT IMITERIALS MILL NOT BE ACCEPTED THAT ARE OVERBROWN, ROOT-BOUND, OR TOO RECENTLY CANNED SO THAT THE ROOT SYSTEM IS NOT THEOROUGHLY ESTABLISHED THEOLOGHOUT THE CALL PRIMMING SHALL NOT BE DONE PRIOR TO DELIVERY EXCEPT AS AUTHORIZED BY OWNER'S REPRESENTATIVE.

1) ALL EXISTING AND PROPOSED SOILS ARE TO BE TESTED FOR VERIFICATION AND DEVELOPMENT OF STANDARDS FOR AMENDING. THIS INCLUDES STOCKPILE AND IMPORT. 2) SOIL AMENDMENTS TO BE APPLIED AT RATES IN ACCORDANCE TO SOIL TESTING FOR

4) SOIL AMENDMENT IN ALL PLANTING AREAS SHALL BE UNIFORMLY SPREAD THOROUGHLY INCORPORATED TO A SOIL DEPTH OF 10" MINIMUM BY REPEATED ROTARY HOE.

CHITIVATION PRIOR TO PLANTING

1) ALL PROPERTY, EASEMENT, VEHICLE CLEARANCES, AND LINIT OF WORK LINES SHALL BE 5) CONTRACTOR TO USE ENVIRONMENTAL ORGANIC AMENOMENTS FOR PREPARATION AND

LICORIUM:

1) CONTRACTOR TO STAKE THE LOCATION OF TREES AND LARGER SHRUB MATERIAL FOR APPROVAL BETORIC INSTALLATION, DISCUSSIONS FOR PLACEMENT AND LAUTOR F PLANT MATERIALS SHOWN ON EDMANNESS ARE PROPOSIONEL. LOUTO OF PLANT MATERIALS SHALL BE APPROVED BY OWNERS AUTHORIZED REPRESENTATIVE PROR TO INSTALLATION OF PLANT MATERIALS.

2) DIG PITS AS SHOWN ON DRAWINGS.

2) DIG PILS 25 SHOWN ON DIMENSION.

PÉRCOLATION EST PROMOE I THEE PIT PERCOLATION TEST FOR DEEP FIVE THESS.
LOCATION OF PERCOLATION OF TESTS ARE TO BE UNBFORKET PROVIDED PROGRESS THE LESTING TO BE PROMOED IN LUCHESS OF THESE INSULANCES. CONTINUENCES TO NOT PROMOED THE PERCOLATION TESTS ON THESE INSULANCES. CONTINUENCES TO NOT PROMOED THE PERCOLATION TESTS ON THE INSULANCES. CONTINUENCES THE PERCOLATION PROMOED THE PERCOLATION THE PERCOLATION THESE INSULANCES. REPRESENTANT FOR RESOLUTION, FERCINENS AMERICAN THE PER TESTING IN A TEST LOCATION WAS THE RESISSANT ON MEDICINE SITE CONTINUENCES.

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3) AFTER PITS ARE DUG. AND PERCOLATION TESTS COMPLETE. BREAK SIDES AND BOTTOM OF HOLES TO OPEN WALL OF PIT FOR ROOT PENETRATION.

4) PLANTING BACKFILL MIX WITH AMENDED SOILS AS OUTLINED IN SOILS TEST.

5) PLANT ROOTBALL CROWN SHALL BE 2" ABOVE FINISH GRADE AFTER WATERING AND

6) PLANTINGS SHALL BE WATERED AND FLOODED TO ELIMINATE AIR POCKETS WITHIN 2

1) AFTER PLANTING IS COMPLETE, FURNISH AND SPREAD MULCH OVER ENTIRE PLANTED AREAS, EXCLUDING LAWN, WITH A 3 INCH MINIMUM DEPTH OF CRUSHED STONE MULCH \$7. NO FINES, TAM TO BROWN IN COLOR. CONTRACTOR TO SUBMIT 3 DIFFERENT SAMPLES FOR INITIAL SELECTION.

PLANTING MAINTENANCE AND ESTABLISHMENT:

1) MAINTENANCE PERIOD MAY NOT BEGIN UNTIL ALL SPECIFIED MATERIALS ARE INSTALLED. 2 CONTRACTOR SHALL BE RESPONSIBLE FOR THE PLANT ESTABLISHMENT ON THE DIFFIC SITE FOR THE DUBLINGH OF THE CONTRACT MAD PLANT ESTABLISHMENT PERDO, AS NORLITHD IN THE SECONDATION, NEUTROLOGY, BUT NOT LIBERT ON, ALL WATERING, MONEY, DOSNE, TRANSE, POUNNE, WEIGH, CERTAZING, AND RESPIRE ALL PLANT ANTERNAL (DIFFI ESTATION AND REVE) HACHITY GERMEN, AND RESPIRE ALL PLANT ANTERNAL (DIFFI ESTATION AND REVE) HACHITY GERMEN CONTRIDES AND REAL AND ATTRACTIVE IN APPEARANCE, REPLACE ALL DEAD AND/OR DAMAGED PLANT MATERIAL ON A WEFKLY BASIS.

3) NO PRE-EMERGENCE HERBICIDES SHALL BE APPLIED DURING MAINTENANCE AND ESTABLISHMENT PERIOD ONLY HAND REMOVAL OF WEEDS WILL BE ALLOWED.

4) FERTILIZATION DURING MAINTENANCE AND ESTABLISHMENT PERIOD WILL USE ORGANIC MATERIALS TREATMENTS ONLY. INSTALL PER MANUFACTURER'S RECONMENDATIONS. INTEGRATED PEST MANAGEMENT PRACTICES SHALL BE IMPLEMENTED.

5) CONTRACTOR TO SUBMIT TO OWNERS AUTHORIZED REPRESENTATIVE A MAINTENANCE PLAN AS DESCRIBED UNDER SPECIFICATION FOR LANDSCAPE MAINTENANCE.

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PLANTING LEGEND

TREES									
SYMBOL	ABBRV.	LATIN NAME	COMMON NAME	QUANTITY	DIA X HT (FT)	SIZE	SPACING	DETAILS	NOTES
·	PC	Prosopis chilensis	CHILEAN MESQUITE	21	30 X 30	36" BOX	AS SHOWN	1/L1.20	
+	PD	Parkinsonia x 'Desert Museum'	DESERT MUSEUM PALO VERDE	5	20 X 20	24" BOX	AS SHOWN	1/L1.20	
	CL	Chilopsis linearis	DESERT WILLOW	38	15 X 15	24" BOX	AS SHOWN	1/L1.20	
SHRUB, GRAS	S AND	GROUND COVER							
SYMBOL		LATIN NAME	COMMON NAME	QUANTITY	DIA X HT (FT)	SIZE	SPACING	DETAILS	NOTES
9	AB	Agave 'Blue Flame'	BLUE FLAME AGAVE	49	3 X 2.5	5 GAL.	3.5' O.C., TRIANGULAR SPACING	3/L1.20	
60	BC	Baccharis pilularis 'Centennial'	CENTENNIAL COYOTE BRUSH	305	4 X 4	5 GAL.	5' O.C., TRIANGULAR SPACING	3/L1.20	
0	HP	Hesperaloe parviflora 'Brakelights'	BRAKELIGHTS YUCCA	44	2.5 X 2.5	5 GAL.	3' O.C., TRIANGULAR SPACING	3/L1.20	
٥	MD	Muhlenbergia dubia	PINE MUHLY	1666	2 X 2	1 GAL.	2.5' O.C., TRIANGULAR SPACING	3/L1.20	
(6)	MR	Muhlenbergia rigens	DEERGRASS	366	4 X 4	5 GAL.	5' O.C., TRIANGULAR SPACING	3/L1.20	
0	SA	Sphaeralcea ambigua	DESERT GLOBEMALLOW	91	3 X 3	5 GAL.			

NOTES: PLANT AREA AND OVERALL QUANTITY OF EACH PLANT TYPE ARE SHOWN ON THE PLANTING SCHEDULE FOR REFERENCE PURPOSES ONLY. CONTRACTOR TO CONFIRM ALL QUANTITIES. ALL AREAS TO BE DENSELY PLANTED PER SPACING IN PLANTING SCHEDULES.

SOIL DEPTHS SCHEDULE

CATEGORY	SOIL DEPTHS
TREE PIT	36" MIN OR EQUAL TO DEPTH OF ROOTBALL FOR TREES DEEPER THAN 36"
SHRUB, GRASS AND GROUND COVER	24"
BIORETENTION	SEE CIVIL DRAWINGS

NOTES: SOIL SHALL BE IMPORTED OR RECONDITIONED PER DETAILS 1/ L121 AND 2/L121 RESPECTIVELY. RECONDITIONED SOIL IS BASED UPON THE EXISTING PLANTING BED WHICH IS LINDISTURBED BY CONSTRUCTION

CITY CASE NO. CITY OF VICTORVILLE ENGINEERING DEPARTMENT

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15272 Bear Valley Road Victorville, CA 92395

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AECOM 1255 Broad St. Suite 201 Clifton NJ 07013 USA 973 883 8500 tel

THE DRIVINGS HAS BEEN PREPARED FOR THE USE OF ALCOURS CLIENT A MAY ARD THE USED. REPRODUCED ON RELED UNIT OF THE OF PREPARED FOR THE OF THE OFFICE PROPARED THE ADDRESS OF LIVE OF THE OFFICE PROPARED THE ARCON ARCHITICAL SHOULD BE OFFICE OFF DO NOT SCALE THIS DOCUMENT, ALL INSASLINEMENTS MUST BE CREWNED FROM STATED DIVIDIDIDIDS.

If BITHS RESPONSIBILITY OF THE CONTRACTORS TO IN-CONTRIBUTES OF THE EXACT LOCATION OF, AND ASSURE ALL LUBLITY THE CHANCE TO ALL UNITIES, REPORTS AND STRUCTURES WE THERE ARRAY TO ROUND OF BELOW CANCE SETTING CONTRIBUTION TO WELL WITH MODERNITOR IS NOT MICE SETTING CONTRIBUTION TO THE DEVIATION, AND WERE SECOND THE ACCURACY.

WITH THE BOLE EXCEPTION OF THE BONDHAMMS SPECIFICALLY DESCRIBED FOR THE PROJECT, NO SUPURITION MINICATED OR ASSUMED HERGON IS TO BE

REGISTRATION



ISSUE/REVISION

1 1		
1	12/01/2020	100% PERMIT SET R1
0	10/13/2020	100% PERMIT SET
I/R	DATE	DESCRIPTION

KEY PLAN

PROJECT NUMBER

60633050 SHEET TITLE

LANDSCAPE NOTES AND PLANTING LEGEND

SHEET NUMBER

L0,01

GIS\912_Lar

MAWA / ETWU CAI CUI ATIONS

/I <i>F</i> \VV	A/EIV	VU CA	LCUL	AHOI	10			
Danida Seculo	d 0.0		Evapol	ference ranapiration (Etc) Etc Etc Etc.2		Convenion Factor (to Gallona/SF) 0.62		Evapotranspiration Adjustment Factor (ETAF) 0.45
	REQUEAR LANDICAPE	AHEAR	Estimat	ed Applied Water	Use (EAWU):			
Hydrocone No.	Hydrocone Description	Hydropoli Area (FT ²)	Plant Factor (PF)	Irrigation Method	Irrigation Efficiency (IE)	(PF/IE)	(ETAF x Area)	Estimated Total Water Use (Gallons) (ETWU)
è	Bruins - Breeiscape Bruins - Parking Lot	7,260.3	0.3 0.3	Drip Area Drip Area	0.81 0.81	0.37 0.37	2,696.30 1,421.48	110,666.79 58,343.29

ETAF. Calcula	Cons
Regular Londecape Areas Average ETAF	0.30

		_
ESTIMATED TOTAL WATER USE (ETWU)	414,808	GALLONS
MAXIMUM ALLOW WATER ALLOWANCE (MAWA)	497,761	GALLONS

CRITICAL ANALYSIS

P.O.C. NUMBER: 01

Sharon Taylor 760.955,2319. *NOT CONFIRMED*

Verify available flow and pressure at existing BFP.

FLOW AVAILABLE

37.50 gpn

PRESSURE AVAILABLE Static Pressure at POC: 81.00 psi Heyaffon Channe 5.00 ft Service Line Size:

Length of Service Line: Pressure Available: DESIGN ANALYSIS

Critical Station: 20,00 psi Eriction Loss: Elevation Loss Loss through Valve Pressure Reg. at Critical Station: 36.47 ns Pressure Red, at Childa Station: Loss for Fittings: Loss for Main Line: Loss for POC to Valve Elevation: Loss for Backflow: Loss for Master Valve: 1.60 psi Loss for Water Meters

VALVE SCHEDULE

Critical Station Pressure at POC: 62.68 psi

NUMBER	MODEL	SIZE	TYPE	GPM	DESIGN PSI	PSI	PSI @ POC	PRECIP
1	RAIN BIRD XCZ-100-PRB-COM	111	AREA FOR DRIPLINE	14.17	20	32.16	60.04	1.16 in/h
2	RAIN BIRD XCZ-100-PRB-COM	1"	AREA FOR DRIPLINE	12.77	20	30.84	54.98	1.15 in/h
3	RAIN BIRD XCZ-100 PRB-COM	111	DRIP EMITTER	2,64	20	22,37	37	0,95 in/h
4	RAIN BIRD XCZ-100-PRB-COM	111	AREA FOR DRIPLINE	12.48	20	30.47	52.17	1.20 in/h
5	RAIN BIRD XCZ-100-PRB-COM	1"	AREA FOR DRIPLINE	9.39	20	27,47	43,70	1,26 in/h
6	RAIN BIRD XCZ-100-PRB-COM	-11	BUBBLER	4.00	20	23.64	36.44	1,73 in/h
7	RAIN BIRD XCZ-100-PRB-COM	1"	AREA FOR DRIPLINE	12.78	20	32,07	47.31	1.37 in/h
8	RAIN BIRD XCZ-100-PRB-COM	1"	AREA FOR DRIPLINE	13.75	20	31.69	51.56	1.15 in/h
9	RAIN BIRD XCZ-100 PRB-COM	111	AREA FOR DRIPLINE	9,72	20	27,33	44,22	1,13 in/h
10	RAIN BIRD XCZ-100-PRB-COM	111	DRIP EMITTER	2.50	20	22.69	34.39	1.00 in/h
11	RAIN BIRD XCZ-100-PRB-COM	1"	AREA FOR DRIPLINE	12.82	20	30.90	51.97	1.13 in/h
12	RAIN BIRD XCZ-100-PRB-COM	-11	AREA FOR DRIPLINE	9.78	20	30.62	47.68	1,24 in/h
13	RAIN BIRD XCZ-100-PRB-COM	1"	BUBBLER	8.00	20	28,29	43.95	1.73 in/h
14	RAIN BIRD XCZ-100-PRB-COM	1"	AREA FOR DRIPLINE	12.56	20	29.56	44.17	1.35 in/h
15	RAIN BIRD XCZ-100 PRB-COM	111	BUBBLER	5,00	20	25,73	36,95	1,73 in/h
16	RAIN BIRD XCZ-100-PRB-COM	111	AREA FOR DRIPLINE	9.42	20	27.03	40.58	1.34 in/h
17	RAIN BIRD XCZ-100-PRB-COM	1"	AREA FOR DRIPLINE	10.52	20	28.06	42,71	1.18 in/h
18	RAIN BIRD XCZ-100-PRB-COM	-11	AREA FOR DRIPLINE	14.02	20	31.99	48.79	1,07 in/h
19	RAIN BIRD XCZ-100-PRB-COM	111	AREA FOR DRIPLINE	11.57	20	28.09	43.43	1.25 ln/h
20	RAIN BIRD XCZ-100-PRB-COM	1"	AREA FOR DRIPLINE	9,71	20	27.32	40.08	1.20 in/h
21	RAIN BIRD XCZ-100 PRB-COM	111	AREA FOR DRIPLINE	10,26	20	27,82	42,96	1,20 in/h
22	RAIN BIRD XCZ-100-PRB-COM	1"	DRIP EMITTER	4.50	20	24.21	33,94	1.00 in/h
23	RAIN BIRD XCZ-100-PRB-COM	1"	AREA FOR DRIPLINE	10.26	20	27.83	44,23	1,20 in/h
24	RAIN BIRD XCZ-100-PRB-COM	-11	AREA FOR DRIPLINE	10.26	20	27.82	45.40	1.20 in/h
25	RAIN BIRD XCZ-100-PRB-COM	111	AREA FOR DRIPLINE	7.92	20	26.37	38	1.31 in/h
26	RAIN BIRD XCZ-100-PRB-COM	1"	BUBBLER	14.00	20	37.79	54,68	4.05 in/h
27	RAIN BIRD XCZ-100-PRB-COM	111	AREA FOR DRIPLINE	7,26	20	25,86	36,33	1,35 in/h
28	RAIN BIRD XCZ-100-PRB-COM	1"	AREA FOR DRIPLINE	9.59	20	26.38	38.84	1,36 ln/h
29	RAIN BIRD XCZ-100-PRB-COM	1"	AREA FOR DRIPLINE	11.79	20	31.43	46,04	1,37 in/h
30	RAIN BIRD XCZ-100-PRB-COM	-11	AREA FOR DRIPLINE	15.48	20	35.10	55.08	1.21 in/h
31	RAIN BIRD XCZ-100-PRB-COM	1"	AREA FOR DRIPLINE	16,59	20	37,53	62,38	1,21 in/h
32	RAIN BIRD XCZ-100-PRB-COM	1"	DRIP EMITTER	7.50	20	28,51	39.23	1.00 in/h
33	RAIN BIRD XCZ-100-PRB-COM	1"	AREA FOR DRIPLINE	15,49	20	36,59	60,92	1,21 in/h
34	RAIN BIRD XCZ-100-PRB-COM	1"	AREA FOR DRIPLINE	15.47	20	36.47	62.76	1,21 in/h
35	RAIN BIRD XCZ-100-PRB-COM	1"	AREA FOR DRIPLINE	7,73	20	26,13	41,44	1,21 ln/h

IRRIGATION NOTES

1. THIS DESIGN IS DIAGRAMMATIC. ALL PIPING, VALVES, ETC. SHOWN WITHIN PAVED AREAS ARE FOR DESIGN CLARIFICATION ONLY. INSTALL ALL COMPONENTS IN PLANTING AREAS WHEREVER POSSIBLE. TOTAL PIPE QUANTITY LISTED ON LEGEND IS FOR ESTIMATING PURPOSES ONLY AND SHALL BE

2. SET ALL VALVES AND QUICK COUPLERS NEXT TO WALKS OR PAVED SURFACES. IN LOCATIONS WITH NO ADJACENT PAVING, COORDINATE FINAL LOCATION WITH OWNER

3. ALL IRRIGATION HEADS ARE TO HAVE TRIPLE SWING JOINTS (EXCEPT WHERE NOTED ON PLANS).

4.NO SUBSTITUTIONS OF SMALLER PIPE SIZES SHALL BE PERMITTED, BUT SUBSTITUTIONS OF LARGER SIZES MAY BE APPROVED.

5. ALL DAMAGED AND REJECTED PIPE SHALL BE REMOVED FROM THE SITE AT THE TIME OF THE SAID

6. CONTROLLER LOCATION SHOWN IS DIAGRAMMATIC, OBTAIN FINAL LOCATION APPROVAL FROM THE LANDSCAPE ARCHITECT AND OWNER PRIOR TO INSTALLATION.

7, 120VAC ELECTRICAL POWER SOURCE AT CONTROLLER LOCATION IS NOT A PART OF THE IRRIGATION SYSTEM, COORDINATE POWER REQUIREMENTS WITH GENERAL CONTRACTOR, ELECTRICAL ENGINEER, LANDSCAPE ARCHITECT AND/OR OWNER.

8, BEFORE COMMENCING ANY WORK, OBTAIN AN UNDERGROUND SERVICE ALERT I.D. NUMBER BY CALLING 1-800-422-4133. ALLOW TWO (2) WORKING DAYS AFTER THE I.D. NUMBER IS OBTAINED AND BEFORE THE EXCAVATION WORK IS STARTED SO THAT UTILITY OWNERS CAN BE NOTIFIED.

9. ALL IRRIGATION HEADS SHALL BE SET PERPENDICULAR TO FINISH GRADE UNLESS OTHERWISE

10. FLUSH AND ADJUST ALL IRRIGATION HEADS AND VALVES FOR OPTIMUM COVERAGE WITH MINIMAL

11. IT IS THE RESPONSIBILITY OF THE IRRIGATION CONTRACTOR TO BE FAMILIAR WITH THE EXISTING SITE CONDITIONS, UTILITIES, GRADE DIFFERENCES, LOCATION OF WALLS, ETC. THE IRRIGATION CONTRACTOR SHALL REPAR OR REPLACE ALL ITEMS DAMAGED BY HIS WORK, HE SHALL COORDINATE HIS WORK WITH OTHER CONTRACTORS FOR THE LOCATION AND INSTALLATION OF PIPE SLEEVES AND LATERALS UNDER ROADWAYS AND PAVING, ETC.

12. THE POTABLE IRRIGATION SYSTEM DESIGN IS BASED ON A MINIMUM OPERATING PRESSURE OF 81 12. THE POLANDE IMMURATION STRIPE MEASON IS ASSED ON A MINIMUM OF PRESSURE OF P.S.I. AND A MAXIMUM FLOW DEMAND OF 25 S.P.M. THE CONTRACTOR SHALL VERIFY WATER PRESSURE PRESSURES PRIOR TO CONSTRUCTION. REPORT MAY DIFFERENCE BETWEEN WATER PRESSURE NDICATED ON THE DRAWNINGS AND THE ACTUAL PRESSURE REQUING AT THE IRRIGATION POINT OF CONNECTION TO THE LANDSCAPE ARCHITECT.

13, DO NOT WILLFULLY INSTALL THE IRRIGATION SYSTEM AS SHOWN ON THE DRAWINGS WHEN IT IS OBVIOUS IN THE FIELD THAT THERE ARE UNKNOWN OBSTRUCTIONS OR GRADE DIFFERENCES IN THE AREA OR DIMENSIONS EXIST THAT MIGHT NOT HAVE BEEN CONSIDERED IN THE ENGINEERING, SUCH OBSTRUCTIONS OR DIFFERENCES SHALL BE ROUGHT TO THE ATTENTION OF THE LANDSCAPE ARCHITECT. IN THE EVENT THAT THIS NOTIFICATION IS NOT GIVEN, THE CONTRACTOR SHALL ASSUME FULL RESPONSIBILITY FOR ANY NECESSARY REVISIONS.

14. ALL IRRIGATION EQUIPMENT NOT OTHERWISE DETAILED OR SPECIFIED SHALL BE INSTALLED AS PER MANUFACTURER'S RECOMMENDATIONS AND SPECIFICATIONS.

15. THE INTENT OF THE DESIGN IS TO PROVIDE 100% COVERAGE TO ALL PLANTING AREAS. AS PART OF THE SCOPE OF MORK, THE CONTRACTOR WILL PROVIDE ANY ADDITIONAL HEADS, SPECIAL NOZZLES, OR PATTERNS TO A CHIEVE PROPER COVERAGE WITH A MINIMUM OF OVER SPRAY AT NO ADDITIONAL COST TO THE OWNER.

16. INSTALLATION OF CONTROL WIRES SHALL FOLLOW MAINLINE ROUTING.

17. PROVIDE SLEEVES AS SHOWN ON DRAWING. USE 2 TIMES DIAMETER MIN. (AND NOT LESS THAN 2") SCH. 80 P.V.C. MIN. DEPTH 24" TO TOP OF LINE.

18. LOCATE VALVE CHART IN CONTROLLER - REDUCE AND ENCASE IN PLASTIC (AS BUILT).

19, GUARANTEE: THE INSTALLED IRRIGATION SYSTEM SHALL BE GUARANTEED FOR A PERIOD OF ONE (1) YEAR FROM THE DATE OF ACCEPTANCE OF THE WORK. SHOULD ANY TROUBLE DEVELOP WITHIN THE TIME SPECIFIED DUE TO INFERIOR OR FAULTY MATERIAL OR WORKMANSHIP, THE ISSUE SHALL BE CORRECTED BY THE CONTRACTOR WITHOUT EXPENSE TO THE OWNER.

20. REFER TO GENERAL NOTES AND SPECIFICATIONS FOR ADDITIONAL INFORMATION REGARDING THIS

21. COORDINATE ALL IRRIGATION MAINLINE AND LATERAL LINE PLACEMENT IN PLANTERS WITH TREE PLACEMENTS, REFER TO PLANTING PLANS. IRRIGATION LINE LAYOUTS CONFLICTING WITH TREE ROOTBALLS SHALL BE CORRECTED BY THE RERIGATION CONTRACTOR WITHOUT EXPENSE TO THE

NOTE:

CONTRACTOR SHALL VERIFY STATIC PRESSURE AND FLOW RATE OF EXISTING IRRIGATION SERVICE AT THE EXISTING BACKFLOW PREVENTER, IRRIGATION SYSTEM IS DESIGNED BASED ON ASSUMED 81 PSI STATIC PRESSURE. CONTRACTOR SHALL IMMEDIATELY NOTIFY LANDSCAPE ARCHITECT OF ANY DISCREPANCY DISCOVERED IN THE FIELD.

SYMBOL	MANUFACTURER/MODEL/DESCRIPTION	QTY	DE
•	RAIN BIRD RWS-B-C-SOCK 1402 ROOT WATERING SYSTEM WITH 4.0" DIAMETER X 36.0" LONG WITH LOCKING GRATE, SEMI-RIGID MESH TUBE, CHECK VALVE AND SAND SOCK, 1402 0,5 GPM.	62	3/1
SYMBOL	MANUFACTURER/MODEL/DESCRIPTION	QTY	DE.
	RAIN BIRD XCZ-10x-PRB-COM WIDE FLOW DRIP CONTROL MIT FOR COMMERCIAL APPLICATIONS. 1" BALL VALVE WITH 1" PESS VALVE AND 1" PRESSURE REGULATING 40PSI QUICK-CHECK BASKET PILTER, 0.36PM TO 200PM.	35	1/L
•	LATERAL TO DRIP AREA TRANSITION PIPE TRANSITION POINT FROM PVC LATERAL TO DRIP TUBING, SUBSURFACE INSTALLATION.	36	1/L
•	RAIN BIRD MDCFPCAP DRIPLINE FLUSH VALVE IN COMPRESSION FITTING COUPLER.	34	5/L
(1)	RAIN BIRD OPERIND DRIP SYSTEM OPERATION INDICATOR	32	6/1.
٥	24" BOX DRIP RING PROVIDE 3 RINGS, 0.6 GPH @ 12" O.C. PRECIP RATE: 0.6 IN/HR.	29	4/L
(a)	36" BOX DRIP RING PROVIDE 4 RINGS, 0.6 GPH @ 12" O.C. PRECIP RATE; 0.6 IN/HR.	4	4/L
	AREA TO RECEIVE DRIPLINE RAIN LERO XESCUGA: 12 XFS-CV SUB-SURFACE LANDSCAPE DRIPLINE WITH A HEAVY-DUTY 4.3 PSI CHECK VALVE, 0.8 GPH EMITTERS AT 12° O.C. DRIPLINE LATERALS SPACED AT 12° APART, WITH EMITTERS OFFSET FOR TRIANGULAR PATTERN. XF INSERT FITTING	24,905 S.F.	2/1
SYMBOL	MANUFACTURER/MODEL/DESCRIPTION	QTY	DE
	RAIN BIRD 44-IRC 1*BRASS QUICK-COUPLING VALVE, WITH CORROSIONARESISTANT STANLESS STEEL SPRING, LOCKING THERMOPLASTIC RUBBER COVER, AND 2-PIECE BODY.	25	7/L
×	MATCO-NORCA.759 BRASS SHUT OFF BALL VALVE, 1/2' TO 4'. TWO PIECE BODY, BLOW-OUT PROOF STEM, CHROME PLATED SOLID BRASS BALL, THREADED, WITH PTFE SEATS, SAME SIZE AS MAINLINE PIPE.	6	4/L
®	BUCKNER-SUPERIOR 3000 NORMALLY CLOSED BRASS MASTER VALVE THAT PROVIDES DIRTY WATER PROTECTION AND 3-WAY SOLENOID DESIGN. MATCH MAINLINE SIZE.	1	8/L
C	RAIN BIRD ESP-LXD-LXMMSS-LXMMSSPED-NCC-WIFI 50 STATION 2-MRE, FLOW SENSING, OUTDOOR-RATED STEEL ENCLOSURE, PEDESTAL MOUNT, WIFI NETWORK MODULE	1	9/L
RS	RAIN BIRD RSD-CEX RAIN SENSING DEVICE, CONDUIT MOUNT, WITH THREADED ADAPTER, EXTENSION WIRE.	1	6/L
FS	RAIN BIRD FS-100-B 1" BRASS FLOW SENSOR. OPERATING RANGE OF 2.0 GPM TO 4.0.0 GPM. SENSORS SHOULD BE SIZED FOR FLOW RATHER THAN PIPE SIZE.	1	8/L
® ₽	EXISTING BACKFLOW PREVENTER VERIEY EXISTING USE AND AVAILABLE FLOW AND PRESSURE, ADJUST EXISTING EQUIPMENT AND ENCLOSURE TO BE LEVEL AND PROPER OR REPLACE IN KND.	(E)	3/L
М	WATER METER 1" SHARON TAYLOR 760 955 2319, "NOT CONFIRMED" VERIFY AVAILABLE FLOW AND PRESSURE AT EXISTING BFP.	(E)	
	IRRIGATION LATERAL LINE: PVC SCHEDULE 40	3,584 L.F.	1/L
	IRRIGATION MAINLINE: PVC SCHEDULE 80	2,892 L.F.	1/L
======	PIPE SLEEVE: PVC SCHEDULE 80 TYPICAL PIPE SLEEVE FOR IRRIGATION PIPE. PIPE SLEEVE SIZE SHALL ALLOW FOR IRRIGATION PIPING AND THEIR RELATED COUPLINGS TO EASILY SLIDE THROUGH SLEEVING MATERIAL. EXTEND SLEEVES 8 INCHES BEYOND EDESS OF PAWING OR CONSTRUCTION.	491.6 L.F.	2/L

IDDICATION FOLIDMENT SCHEDULE





CITY CASE NO.

CITY OF VICTORVILLE **ENGINEERING DEPARTMENT**

DFX4 - Victorville, CA

15272 Bear Valley Road Victorville, CA 92395

CLIENT

CONSULTANT

1255 Broad St. Suite 201 Clifton NJ 07013 USA 973 883 8500 tel

REGISTRATION



ISSUE/REVISION

1	12/01/2020	100% PERMIT SET R1
0	10/13/2020	100% PERMIT SET
/R	DATE	DESCRIPTION

KEY PLAN


PROJECT NUMBER


SHEET TITLE IRRIGATION NOTES. CALCULATIONS, AND LEGEND


SHEET NUMBER


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CLIENT

TREE PLANTING ON GRADE

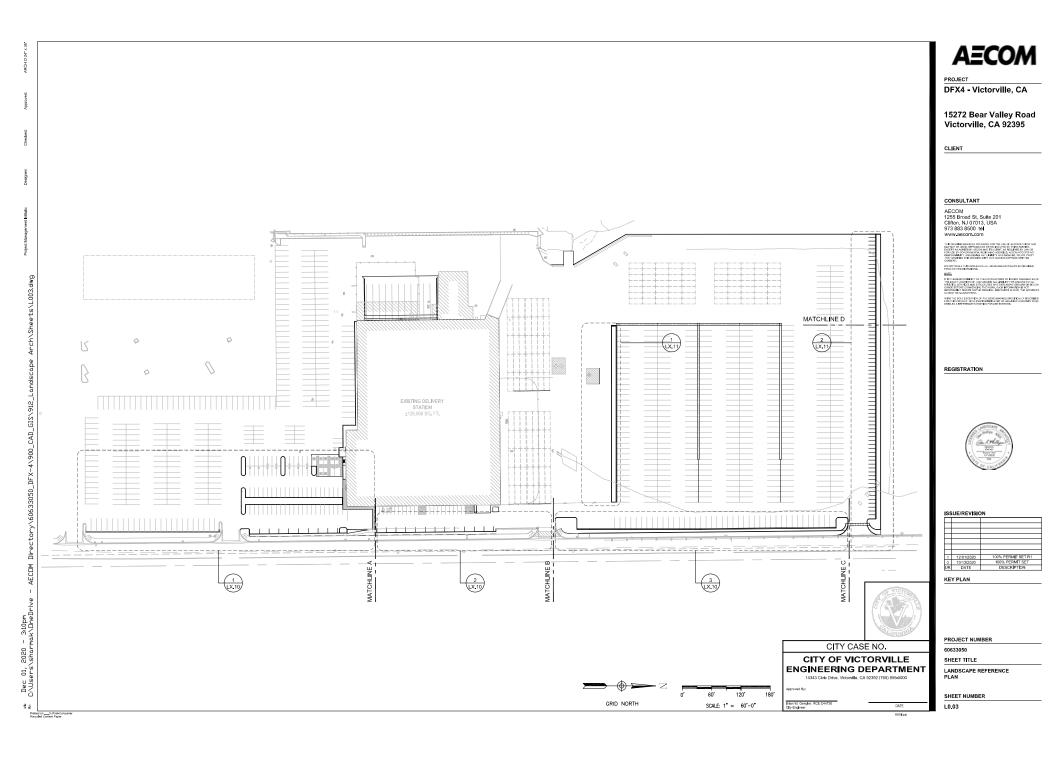SCALE: 1/2"=1"-0"

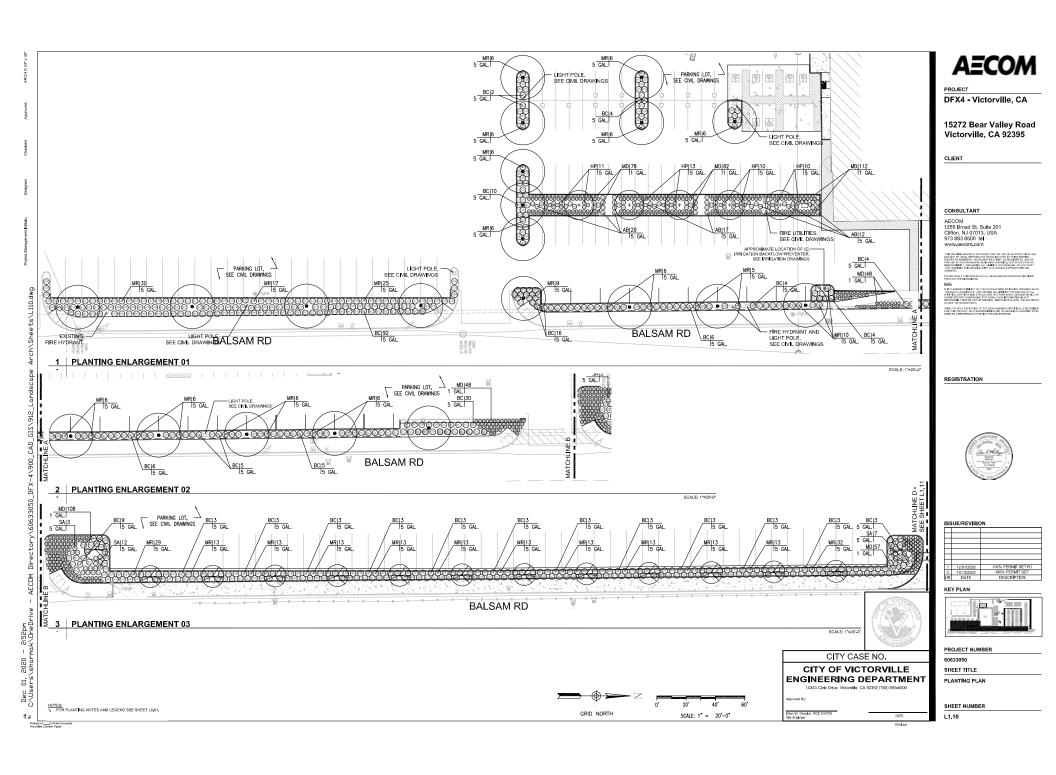CITY CASE NO.

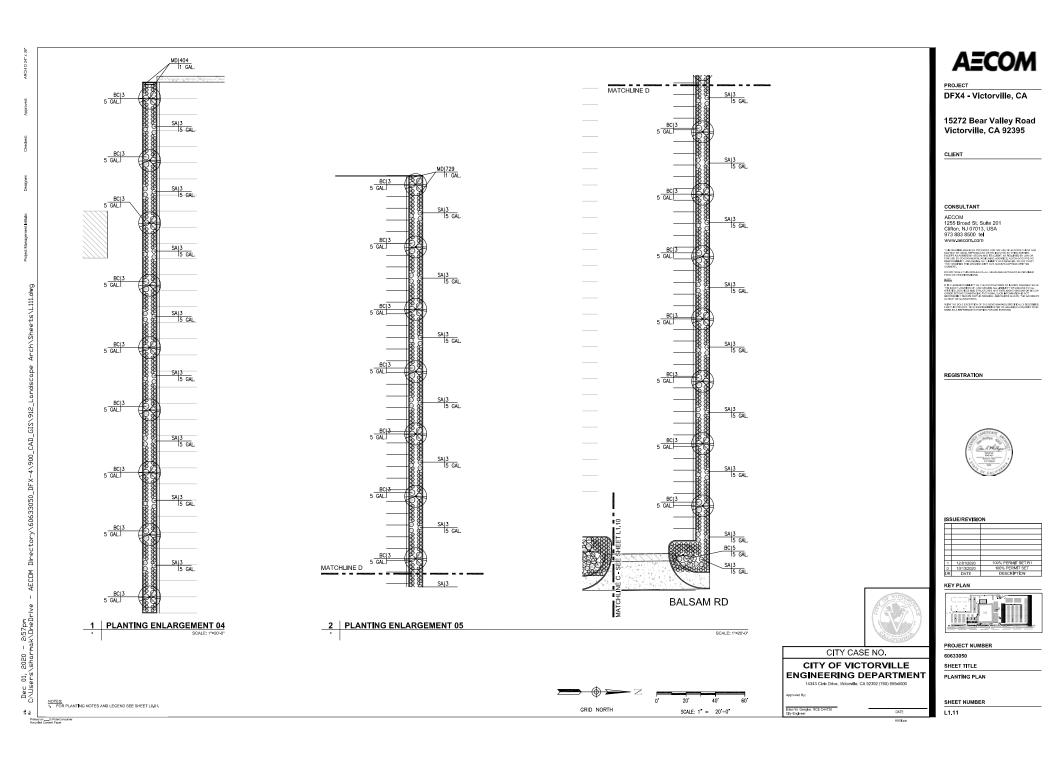CONSULTANT

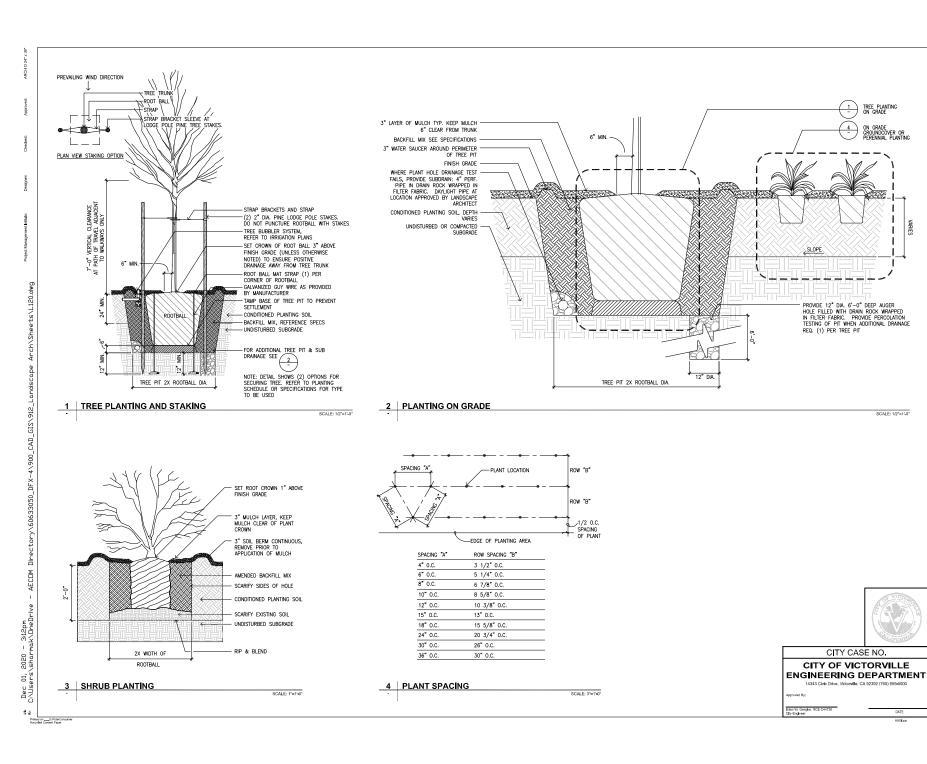1255 Broad St. Suite 201 Clifton, NJ 07013, USA 973 883 8500 tel

IT IS THE RESPONSIBILITY OF THE CONTRACTORS TO INFORM THEMSELVES OF THE EXACT LOGARDOOR. AND ASSESSED ALL LIBELITY THE CHARGE OF THE CHARGE TO ALL THEMSELVES HE PREVIOUS AND STRUCTURES HIERTHER AND/OF GOODING OF BECOMING SETTING THE WORK SUCH PROPERATION IS NOT MICESSAUGHT SHOWN OF THE CANDIDAL AND WHERE SHOWN THE ACCURACY.

WITH THE BOLE EXCEPTION OF THE BONDHAMMS SPECIFICALLY DESCRIBED FOR THE PROJECT, NO SUPURITION MINICATED OR ASSUMED HERGON IS TO BE

REGISTRATION



1	12/01/2020	100% PERMIT SET R1
0	10/13/2020	100% PERMIT SET

KEY PLAN

ISSUE/REVISION

PROJECT NUMBER

60633050 SHEET TITLE

PLANTING DETAILS

SHEET NUMBER

L1,20

Dec 01, 2020 – 314pm Ci\Users\sharmak\OneDrive

1. STEP 1: REMOVE EXISTING SOIL TO PROPOSED ELEVATION PER ROUGH GRADE PER CIVIL GRADING MINUS DEPTH OF SPECIFIED IMPORT PLANTING SOIL, MULCH LAYER, AND 1

- 2. STEP 2: PLACE 3" LAYER OF IMPORT TOPSOIL AND ROTOTILL INTO THE EXISTING SUB-GRADE SOIL 6" DEEP TO BREAK SOIL INTERFACE.
- 3. STEP 3: SPREAD 9" OF IMPORT TOPSOIL.
- 4. STEP 4: PLACE SOIL, AMEND AND FERTILIZE PER SPECIFICATIONS OR RECOMMENDATIONS FROM SOILS REPORT AND ROTOTILL 6 INCHES DEEP.

NOTES:

- ROTOTILL AT EACH STEP TO 6" MIN, DEPTH SEE SOILS PREPARATION PLANS FOR SOIL DEPTH LOCATIONS. PREPARED SOILS DURING EACH LIFT AND FINAL INSTALLATION SHALL HAVE A COMPACTION RATE RANGE OF 75% TO 85% STANDARD PROCTOR

1 PLANTING SOIL PROFILE 24" IMPORT SOIL

STEP 2

STEP 3

STEP 3

STEP 4

STEP 1

SCALE: 1"=1'-0"

1. STEP 1: ADJUST EXISTING SOIL TO PROPOSED ELEVATION PER ROUGH GRADE PER CIMIL GRADING MINUS 4" ADJACENT TO PAVEMENT EDGES, ASSURE THAT SUB-GRADE IS AT COMPACTION RANGE OF 75% TO 85% STANDARD PROCTOR AND PROVIDES PERCOLATION.

2. STEP 2: REMOVE ALL DEBRIS INCLUDING STUMPS, STICKS, ROOTS, AND ROCKS BISGER THAN 11. ONCE REVIEWED AND APPROVED BY OWNERS AUTHORIZED REFRESENTATIVE. VERIFY POSITIVE DRAINAGE, SCARIFY EXISTING SOLS TO MAINTAIN A COMPACTION RANGE OF 75% TO 85% TO A DEPTH. OF 1'-0" TO 2'-0" PER SOIL PREPARATION DEPTHS SHOWN ON

3. STEP 3: AMEND AND FERTILIZE PER SPECIFICATIONS OR RECOMMENDATIONS FROM SOILS REPORT AND ROTOTILL 6".

NOTES:


- 1. PLANTING PREPARATION OF NATIVE SITE SOIL IS BASED ON FORM ING PREFARM ION OF NATIVE SHE SUIL IS BASED ON A ACCEPTANCE FROM OWNERS AUTHORIZED REPRESENTATIVE WITH VERHICATION OF PLANTING SUITABILITY FROM SOIL TESTING AND REQUIREMENTS AS STATED IN SPECIFICATIONS. SOILS NOT SUITABLE FOR PLANTING WILL BE REMOVED AND REPLACED WITH IMPORT SOIL SUITABLE FOR PLANTING.
- REPLACED WITH IMPORT SOIL SUITABLE FOR PLANTING.
 SEE SOILS PREPARATION PLANS FOR SOIL DEPTH LOCATIONS.
 PREPARED SOILS DURING EACH LIFT AND FINAL INSTALLATION
 SHALL HAVE A COMPACTION RATE RANGE OF 75%TO 85% STANDARD PROCTOR.

2 RESTORATION OF EXISTING PLANTING SOIL

STEP 2

2'-0" PER

STEP 1

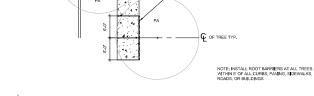

3 | LINEAR ROOT BARRIER

PA



SCALE: 1/8"=1"-0"

CITY CASE NO. CITY OF VICTORVILLE

ENGINEERING DEPARTMENT

LINEAR ROOT BARRIER AT

- LINEAR ROOT BARRIER OR WATER BARRIER AS NOTED BY PLAN AND SPECS, TYP

CONCRETE CURB

AECOM

DFX4 - Victorville, CA

15272 Bear Valley Road Victorville, CA 92395

CLIENT

CONSULTANT

AECOM 1255 Broad St. Suite 201 Clifton, NJ 07013, USA 973 883 8500 tel

WITH THE BOLE EXCEPTION OF THE BONDHAMMOS SPECIFICALLY DESCRIBED FOR THE PROJECT, NO SUPURITION MISTARED OR ASSUMED HERSON IS TO BE

REGISTRATION



ISSUE/REVISION

1	12/01/2020	100% PERMIT SET R1
0	10/13/2020	100% PERMIT SET
I/R	DATE	DESCRIPTION

KEY PLAN

PROJECT NUMBER

60633050


SHEET TITLE


PLANTING DETAILS

SHEET NUMBER

L1,21

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ATTACHMENT B

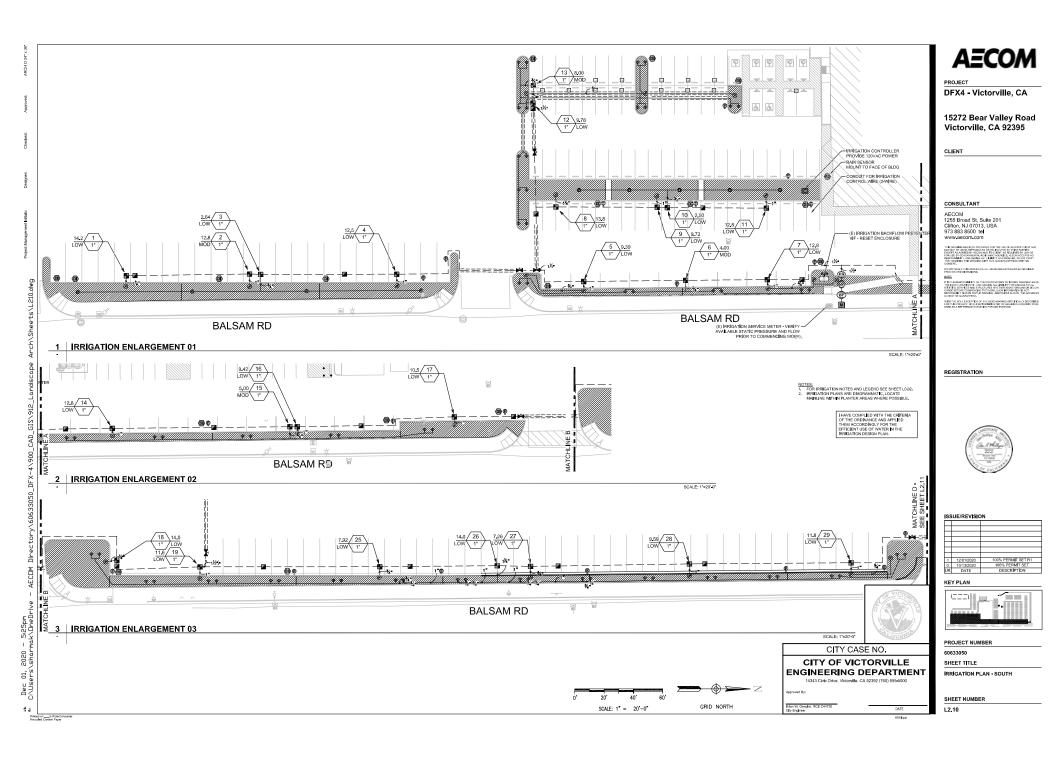PROJECT DFX4 - OPERATIONAL NARRATIVE / As OF AUGUST 25, 2020

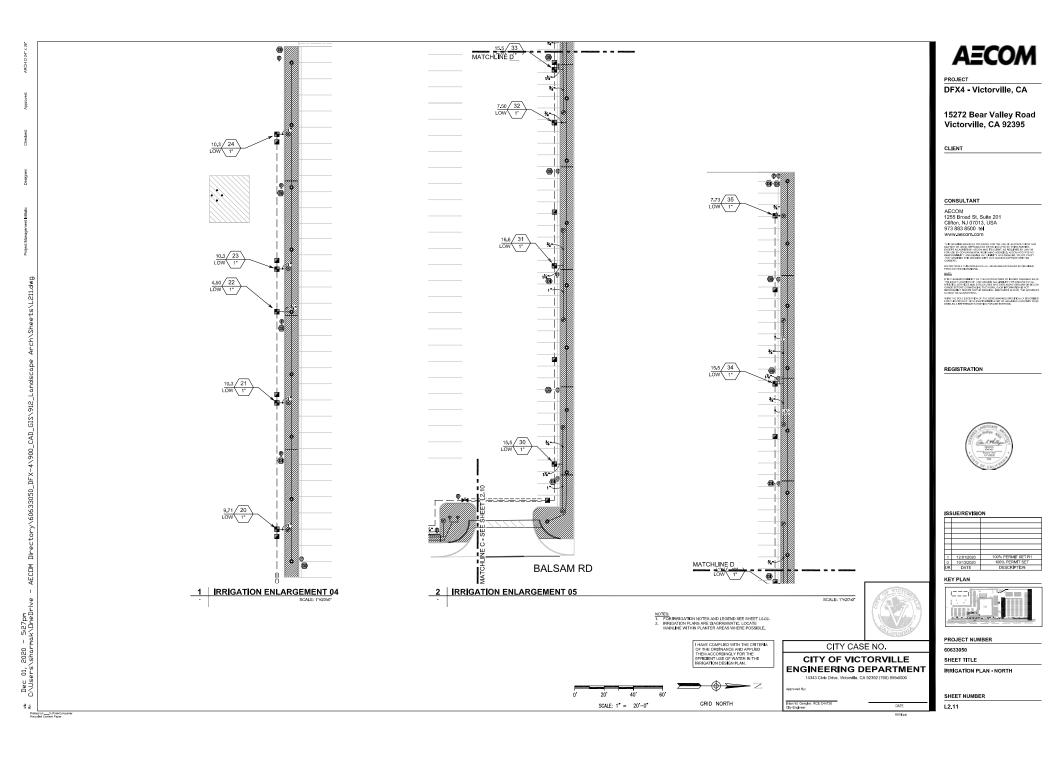The Tenant for Project DFX4 is focused on being the most customer centric company in the world. This facility, a "Delivery Station" specializes in delivery of customer orders, which power the last mile of their customer order process and help speed-up deliveries for customers. Their growth in Victorville, CA is the result of an outstanding workforce, strong local support, and incredible customers. Their associates and customers in this region are also your residents, and we want to ensure they are being good neighbors.

Employment

Delivery stations create hundreds of mostly full time and part time jobs. The Tenant provides all associates at least \$15.00 per hour in wages, and a variety of benefits packages from day one. Full time associates receive benefits including medical, dental and vision insurance, 401k match, and life and disability insurance – the same benefits as our senior executives. Part time opportunities are great for parents seeking flexibility in schedule, college students, those seeking second jobs, and retirees.

Three types of jobs are available in delivery stations:

- 1. <u>Sortation</u> These associates are directly employed by the Tenant. They help with sorting packages inside the delivery station.
- 2. <u>Delivery Service Partners (DSP)</u> DSPs are entrepreneurs who have launched their own small business delivering packages on behalf of the Tenant. DSPs operate out of the Tenant's delivery stations and employ delivery van drivers who deliver the Tenant's packages. They adhere to the \$15.00 per hour wage requirement for their employees.
- 3. <u>Managers</u> Managers are employed by the Tenant for managing the sortation process, and by DSP owners for managing the delivery process.

DSP drivers and Tenant Flex drivers generally handle delivery to customers from delivery stations. Tenant Flex is an innovative service where independent contractors can be their own boss and create their own schedules delivering packages on behalf of the Tenant.

Delivery Service Partner (DSP) Program

The DSP program helps entrepreneurs build their own businesses delivering the Tenant's packages in their local communities. The Tenant takes an active role helping interested entrepreneurs start and manage their delivery business. DSPs get delivery volume from the Tenant, access to the company's sophisticated delivery technology and discounts on a suite of assets and services including discounted vehicle leases and comprehensive insurance to keep startup costs low.

Tenant Flex Program

Launched in 2015, Tenant Flex is an innovative program that gives independent contractors the opportunity to be their own boss while delivering for the Tenant. Flex partners use their own vehicles and set their own schedule via the Tenant's Flex app (available on Android and iOS devices), freeing up time to pursue their goals and dreams, such as finishing school, building a business or spending time with their family. On average, Tenant Flex drivers earn more than \$22 per hour.

Tenant Operations

Delivery stations power the last mile of the Tenant's order fulfillment process and help speed up deliveries for customers. Packages are transported to delivery stations via trailer trucks (18 wheelers) from neighboring Tenant fulfillment and sortation centers and are sorted, picked and loaded into delivery vehicles.

Delivery stations operate 24/7 to support delivery of packages to at customer locations between 10:00 AM and 9:00 PM. At their proposed Victorville, CA facility, the Tenant anticipates approximately Eighteen (18) line haul trucks delivering packages to the delivery station each day, in any 24 hour period. The customer packages are unloaded, sorted, picked to the delivery routes, placed onto movable racks and staged for dispatch. Approximately 150 Tenant associates (in total) support this operation with the majority of the associate shift structure designed between 1:30 AM and 12:30 PM (approximately 105 at those times) that mitigates traffic impact during rush hour periods. The additional 45 Tenant associates arrive and depart between 1:00 PM and 10:00 PM that make up additional support of operations.

The DSP delivery associates arrive at a delivery station at 8:30 AM. Starting at 9:00 AM and ending at 11:00 AM, approximately 200 delivery vans will load and depart from the delivery station at an average rate of 50 vans every 30 minutes to facilitate a regulated traffic flow into the surrounding area. Meaning, the first wave of 50 delivery vans depart the station at 9:00 AM. The departure window is designed to mitigate impact on rush hour periods. Approximately 8-10 hours after dispatch, delivery routes are completed and the vans return to the station between 7:00 PM and 9:00 PM. The drivers park the delivery van onsite and leave using a personal vehicle or public transport.

The Tenant will also use Tenant Flex to deliver packages from this location. Tenant Flex works in concert with an advanced logistics systems and technology that the Tenant has been building since day one. The Tenant anticipates approximately 50 traditional passenger vehicles entering the facility staggered between 4:00 PM and 5:00 PM. Flex vehicles will load and depart every 20 minutes.

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ATTACHMENT C



TRAFFIC ASSESSMENT

Date: October 12, 2020

To: Anwar Wagdy, City of Victorville Engineering Department

From: BenJetta Johnson, PE (benjetta.johnson@NV5.com)

Victoria Guobaitis, T.E., PTOE (victoria.guobaitis@NV5.com)

Re: Proposed Delivery Station

15272 Bear Valley Road Victorville, CA 92395

NV5 has prepared the traffic assessment of a proposed distribution warehouse facility at the Bear Valley Plaza Shopping Center. The vacant retail center is located along Bear Valley Road at the intersection of Balsam Avenue. The proposed delivery station would occupy a 126,395 square foot building previously utilized as a Walmart retail store. The facility would include designated onsite parking facilities and loading areas to fit an end-tenant operations plan. Current access to the shopping center includes an entrance on Bear Valley Road, and three entrances on Balsam Avenue.

Pre-Existing Conditions

Traffic projections for the former Walmart retail store have been prepared utilizing data published in the Institute of Transportation Engineers (ITE) Trip Generation Manual, 10^{th} Edition. Trips were calculated utilizing ITE Land Use Code 820: "Shopping Center"; resulting in 7,050 daily, 89 AM and 388 PM peak trips. It should be noted that the PM peak hour trips reflect pass-by trip reductions. Walmart provides a wide variety of consumer goods, with operating hours that extend from early morning to midnight. Traffic generated by the store is not concentrated to peak hour periods; but well-distributed throughout the day. A copy of the ITE trip generation data is provided in Attachment A.

Proposed Conditions

The proposed end-tenant has provided a traffic schedule for the delivery station facility which provides detailed shift and vehicle classification data. This schedule was examined to determine whether the use of ITE trip generation methodology is appropriate for the site. ITE does not have a specific land use code for a delivery station and trip estimates for other warehouse/distribution uses generate fewer daily and peak hour trips. The proposed delivery station has specific operations plans such that vehicle trips to the facility may not coincide with the adjacent roadway peak hours of traffic. Tractor-trailers will bring goods to the site and unload primarily during overnight and early morning hours. Items arriving by tractor trailer go out for delivery to consumers the same day. Managers and warehouse employees work at the site each day, staggered over multiple shifts. Delivery personnel arrive at the site in their personal vehicles, exchange them for a fleet vehicle (van) parked onsite, load packages from designated staging and loading areas; and leave the site to make deliveries over an eight- to ten-hour period. Delivery personnel return from their deliveries, drop off their van, then leave the site for the day in their personal vehicle. Additional independent drivers arrive at the site for loading and use their own personal vehicles to make deliveries, without returning to the site. An hourly breakdown of the daily projected trips to/from the facility is provided in Attachment B.

The delivery station is expected to generate 541 daily, 1 AM and 35 PM peak trips during normal operations. It should be noted that the proposed delivery station will experience peak seasonal operations from mid-November through the Christmas holiday season. During the peak season operations, the delivery station is expected to generate 1,275 daily, 72 AM and 169 PM peak trips. These trips will be made up of a combination of passenger cars, vans, and tractor trailers. An adjustment factor of 2.5 was applied to trucks to convert these trips to a passenger car equivalent; resulting in 569 daily, 3 AM and 35 PM peak hour trips during normal operations and 1,343 daily, 75 AM and 172 PM peak hour trips during peak seasonal operations.

Trip Generation Comparison

The table below provides the comparative trip generation for the former retail store and proposed delivery station during normal and peak seasonal operations.

Table 1: Pre-Existing and Proposed Trips Comparison

Condition	Land Use	ITE Code	Size	Trips ¹			
Condition	Land USE	TIE Code	Size	Daily	AM Peak	PM Peak	
Pre-Existing	Walmart	820 – Shopping Center	126,395 SF	7,050	89	388	
Proposed	Delivery Station (Normal Operations)	N/A - User Data ²	126,395 SF	569	3	35	
Proposed	Delivery Station (Peak Operations)	N/A - User Data ²	126,395 SF	1,343	75	172	

¹ Passenger Car Equivalent Trips; Adjustment factor for 3-axle trucks = 2.5 Passenger Cars

During normal operations, the proposed delivery station will generate significantly less traffic throughout the day and in the peak hours compared to the former Walmart retail store. During peak season operations, the delivery station will also generate fewer daily and peak hour trips compared to the former Walmart retail store.

Conclusions

The proposed delivery station would occupy a 126,395 square foot building at the Bear Valley Plaza Shopping Center previously utilized as a Walmart retail store. During normal and peak seasonal operations, the proposed delivery station will generate significantly fewer daily and peak hour trips compared to the former use. Since the daily trips and resulting vehicle-miles traveled (VMT) generated by the proposed delivery station will be less than the former use, no California Environmental Quality Act (CEQA) VMT Analysis will be required. The conversion of the Walmart retail store to the proposed distribution warehouse facility will not have an adverse impact on traffic in the surrounding area.

² Proposed End-Tenant Traffic Schedule

Attachment A: Traffic Schedule

Shopping Center (820)
Based upon methodology from ITE's Trip Generation, 10th Edition (2017)

The State of the S	Daily AM Peak Hour PM Peak Hour Saturday Dis Saturday Peak Hour (of generator)		Project Trips				Terrent		ln/	Out
Project Land Use				Inbound	3,525 33 82 10 336 153 5,153	ITE Code	Variable 1,000 SF	Equation Used ¹	Distribution	
Shopping Center				3,525 133 310 5,153 387				Ln(T)=0.68Ln(X) + 5.57 T _{AM} = 0.50(X) + 151.78 Ln(T _{PM})=0.74Ln(X) + 2.89 Ln(T)=0.62Ln(X) + 6.24 Ln(T)=0.79Ln(X) + 2.79	50% 62% 48% 50% 52%	50% 38% 52% 50% 48%
Reductions for Pass-By Trips	Daily AM Peak Hour PM Peak Hour Saturday Daily Saturday Peak Hour	40% 40%	0 0 -258 0 -298	0 0 -124 0 -155	0 0 -134 0 -143					
TOTAL PROJECT TRIPS	Daily AM Peak Hour PM Peak Hour Saturday Daily Saturday Peak Hour		7,050 215 388 10,306 447	3,525 133 186 5,153 232	3,525 82 202 5,153 215					

Attachment B: Traffic Schedule

		Autos			Trucks			Vans			Total	
Time	In	Out	Total	In	Out	Total	In	Out	Total	In	Out	Total
00:00	0	0	0	0	0	0	0	0	0	0	0	0
01:00	41	0	41	1	0	1	0	0	0	42	0	42
02:00	0	0	0	0	1	1	0	0	0	0	1	1
03:00	0	0	0	0	o	0	0	0	0	0	0	0
04:00	0	0	0	1	1	2	0	0	0	1	1	2
05:00	13	0	13	0	0	0	0	0	0	13	0	13
06:00	0	0	0	1	0	1	0	0	0	1	0	1
07:00	0	0	0	0	1	1	0	0	0	0	1	1
07:30	0	0	0	0	0	0	0	0	0	0	0	0
08:00	0	0	0	0	0	0	0	0	0	0	0	0
08:30	0	0	0	0	0	0	0	0	0	0	0	0
09:00	45	0	45	1	0	1	0	0	0	46	0	46
10:00	32	0	32	0	1	1	0	86	86	32	87	119
11:00	2	0	2	0	0	0	0	0	0	2	0	2
12:00	0	41	41	0	0	0	0	0	0	0	41	41
13:00	22	0	22	0	0	0	0	0	0	22	0	22
14:00	0	13	13	0	0	0	0	0	0	0	13	13
15:00	0	0	0	0	0	0	0	0	0	0	0	0
16:00	23	0	23	0	0	0	0	0	0	23	0	23
16:30	0	12	12	0	0	0	0	0	0	0	12	12
17:00	0	11	11	0	0	0	0	0	0	0	11	11
17:30	0	0	0	0	0	0	0	0	0	0	0	0
18:00	0	9	9	1	0	1	0	0	0	1	9	10
19:00	0	21	21	0	1	1	47	0	47	47	22	69
20:00	0	51	51	1	0	1	39	0	39	40	51	91
21:00	0	5	5	0	1	1	0	0	0	0	6	6
22:00	0	15	15	1	0	1	0	0	0	1	15	16
23:00	0	0	0	0	1	1	0	0	0	0	1	1
Total	178	178	355	7	7	14	86	86	172	271	271	541

1st Shift:	2:00 AM	12:30 PM	45	Assoc.
2nd Shift:	6:00 AM	2:30 PM	14	Assoc.
3rd Shift:	1:30 PM	10:00 PM	14	Assoc.
PFSD Shift	2:00 PM	6:00 PM	10	Assoc.
RTS Shift:	12:00 PM	10:30 PM	2	Assoc.
Drivers:	9:20 AM	8:50 PM	86	Drivers

ATTACHMENT D



Date:

November 23, 2020

Project:

ADMIN 20-096

15272 Bear Valley Road

Reviewer:

Gary Koontz

Email:

gkoontz@burrtec.com

Phone:

(909) 429-4200

X Comments
Approval

Project Description: Construct an Amazon distribution facility

Comments: The Site Plan dated 10/13/20 does not identify any trash enclosures or other waste and recycling facilities. Please identify the location(s) of any proposed trash enclosures. All enclosures should be designed to accommodate at least two standard 4-cubic yard commercial bins, one each for trash and mixed recyclables. Please identify any additional methods of waste and recyclables management including compactors and balers.

Any changes to the overall project design, enclosure specifications or location, or access may adversely impact Burrtec's ability to service the project. Any design modifications that could impact Burrtec's service will be subject to review and approval by Burrtec.

Prior to issuance of grading permits, the developer or their contractor shall contact Burrtec to coordinate the preparation and implementation of a Construction Waste Management Plan.

Burrtec's review of this project is limited to determining whether it meets Burrtec's minimum standards for waste and recycling collection services. Any comments or approvals by Burrtec are limited to these minimum standards as they relate to our equipment and personnel and do not pertain to the project's compliance with applicable federal, state and local land use and environmental laws, building codes or other applicable government regulations. Any approvals by Burrtec do not warrant or represent that Burrtec accepts any liability relative to the performance of waste and recycling collection services within this project.

Gary Koontz, Facility Project Manager

Mojave Desert Air Quality Management District


Brad Poiriez, Executive Director
14306 Park Avenue, Victorville, CA 92392-2310
760.245.1661 • Fax 760.245.2022
www.MDAQMD.ca.gov • @MDAQMD

November 23, 2020

City of Victorville Planning Division 14343 Civic Drive Victorville, CA 92392

Subject: ADMN20-00096

Dear Planning Division:

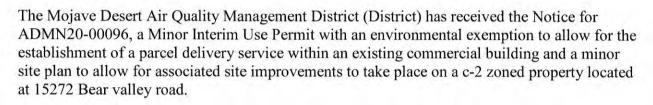

We have reviewed the project and, based on the information available to us at this time, the District has several comments

- A Dust Control Plan will be required for parking lot construction portion of this project.
 The most current Dust Control Plan Requirements and Dust Control Plan Submission
 Form are available at http://mdaqmd.ca.gov/permitting/compliance-forms.
- Signage compliant with Rule 403 Attachment B shall be erected at each project site entrance not later than the commencement of construction.
- Use a water truck to maintain moist disturbed surfaces and actively spread water during visible dusting episodes to minimize visible fugitive dust emissions. For projects with exposed sand or fines deposits (and for projects that expose such soils through earthmoving), chemical stabilization or covering with a stabilizing layer of gravel will be required to eliminate visible dust/sand from sand/fines deposits.
- Certain demolition portions of the project may require an asbestos survey and notification. Asbestos survey notification information can be located at: https://www.mdaqmd.ca.gov/permitting/asbestos-information
- Per MDAQMD and CEQA guidelines this project exceeds significance threshold criteria number 4, potentially exposing sensitive receptors to substantial pollutant concentrations. This project must therefore be evaluated to determine impacts to sensitive receptors using CalEEMod methods (or the equivalent). If the project is deemed to result in a cancer risk greater than or equal to 10 in a million and/or a Hazard Index (HI)(non-cancerous)



greater than or equal to 1, it must incorporate mitigation sufficient to reduce project impacts to a level that is not significant. CEQA guidelines may be located at: https://www.mdaqmd.ca.gov/home/showpublisheddocument?id=8510.

Thank you for the opportunity to review this planning document. If you have any questions regarding this letter, please contact me at (760) 245-1661, extension 6726, or Bertrand Gaschot at extension 4020.

Sincerely,

Alan J. De Salvio

Deputy Director – Mojave Desert Operations

AJD/bg

Victorville ADMN20-00096

ATTACHMENT E

CASE: ADMN20-00096



MEMORANDUM

DATE:

DECEMBER 16, 2020

TO:

ZONING ADMINISTRATOR

FROM:

ALEX JAUREGUI

SENIOR PLANNER

SUBJECT:

REVISED CONDITIONS OF APPROVAL FOR CASE NO. ADMN20-00096— A MINOR INTERIM USE PERMIT WITH AN ENVIRONMENTAL EXEMPTION TO ALLOW FOR THE ESTABLISHMENT OF A PARCEL DELIVERY SERVICE WITHIN AN EXISTING COMMERCIAL BUILDING AND A MINOR SITE PLAN TO ALLOW FOR ASSOCIATED SITE IMPROVEMENTS TO TAKE PLACE ON A C-2 ZONED PROPERTY LOCATED AT 15272 BEAR VALLEY ROAD; URBANEST

GROUP, INC., APPLICANT

AGENDA ITEM NO. 1

Minor Site Plan Conditions of Approval

After review of the Staff Report and proposed Conditions of Approval, the applicant has requested that conditions relating to locating existing Southern California Edison (SCE) power lines underground be removed due to the submittal of correspondence from SCE (Attachment A) that confirms the subject power lines are over the undergrounding threshold of 34.5 kV. Therefore, Staff finds that Minor Site Plan Conditions 24 & 54 (noted as Conditions 22 & 52 in the SCE correspondence) are no longer necessary and can be omitted if the proposal is approved.

Minor Interim Use Permit Conditions of Approval

After review of the Staff Report and proposed Conditions of Approval, the applicant has requested that Minor Interim Use Permit Condition 1 be revised to reflect proposed operations noted in the tenant's legal documents (Attachment B). Staff does not object to the proposed revisions, which are minor and do not result in changes to the findings noted in the Staff Report. The proposed revision to Minor Interim Use Permit Condition 1 is provided as follows:

"This approval is to allow for the operation of a parcel delivery service with accessory office and customer service area (e.g. package pick-up and return) located at 15272 Bear Valley Road. Facility hours of operation are 24 hours a day seven days a week with general functions as follows:

- Facility Operations 24 hours a day seven days a week with 1:30AM-12:30PM shift (approximately 105 employees) and a 1PM-10PM shift (approximately 45 employees).
- Delivery Operations Loading beginning at 8:30AM and waves of approximately 50 70 delivery service partner vehicles departing the facility every 30 20 minutes between 9AM-11:10AM. Delivery service partner vehicle will return between 7PM-9:10PM where vehicles are parked on-site. Independent contractors loading/departure from 4:30PM-56:00PM with staggered departure every 20 15 minutes.
- Customer Service Operations (In person) 10AM-9PM daily.

The Zoning Administrator may allow revised hours of operation and accessory or revised services not listed in this approval, providing the primary use does not change and the changes do not



negatively affect the public health, safety, and welfare nor cause nonconformance with the City Council Policy for Interim Uses (CP-11-05)."

Recommendation:

Open the public hearing and proceed with the Staff recommendation noted in the Staff Report, with the exception of omitting Minor Site Plan Conditions 24 & 54 and revising Minor Interim Use Permit Condition 1 as noted herein.

Therefore, this matter is presented for consideration.

Attachments:

Attachment A – SCE Correspondence

Attachment B - Condition Revision Request

ATTACHMENT A



Jennifer Farley

Sr. Right of Way Agent Vegetation & Land Management Land Management, Eastern Region

December 11, 2020

City of Victorville City Planning Department Attn: Alex Jauregui

SUBJECT:

Confirmation of Southern California Edison (SCE) facilities located at 15272 Bear Valley

Rd., Victorville / APN: 3093-291-01-0000 & 3093-271-07-0000

Dear Mr. Jauregui:

I hope this letter finds you well.

This letter is in response to the City's request for confirmation of voltage for SCE facilities at the above location.

Planning Condition 22

Prior to the issuance of a building permit, the applicant/developer shall provide verification that the electrical transmission lines traversing the center of the site from east to west are designed for over 34.5 kV nominal. Should these transmission lines be designed for less than 34.5 kV nominal, the applicant shall be required to relocate said transmission line underground unless otherwise waived by the City Engineer or suspended by the Planning Commission with proper application and fee's submitted by the applicant/developer.

SCE response: The electrical transmission lines traversing the center of the site from east to west are 115kV / 115,000 volt electric lines known as the Victor-Savage #1 to the north and Victor-Savage #2 to the south.

Engineering Condition 52

Pursuant to Section 16-5.12.170 of the City's Municipal Code, the owner/developer must underground the existing above ground utilities along the Balsam Road frontage and the project site if the electrical lines are 34,000 volts or under. The site plan must be revised to show the existing power poles and the required undergrounding.

SCE response: The electrical transmission lines along the Balsam Road frontage is the same Victor-Savage #2 115kV / 115,000 volt electric line.

I hope this information helps to meet the above referenced conditions. Please do not hesitate to let me know if you have any questions, my contact information is below.

Sincerely,

mifes Farley Yennifer Farley

Sr. Right of Way Agent

Vegetation & Land Management | Land Management - Eastern Region

Southern California Edison

Cell: 909-586-1042

jennifer.farley@sce.com

Cc: Tarek Shaer, Urbanest Group

Bruce Palmer, BJ Palmer & Associates, Inc.



2 Innovation Way, 2nd Floor Jennifer Farley Pomona, CA 91768 909-274-1600/PAX 61600 Real Properties Cell: 909-586-1042 jennifer.farley@sce.com

Land Services Agent 5 Land Management Eastern

ATTACHMENT B

Alex Jauregui

From: Sent: Tarek Shaer < Tarek@UrbanestGroup.com> Wednesday, December 16, 2020 8:23 AM

To:

Alex Jauregui

Subject:

Bear Valley Condition

Attachments:

Adjusted Condition 1.docx

Importance:

High

[EXTERNAL EMAIL]: This email originated from outside of the organization. Do not click links or open attachments unless you recognize the sender and know the content is safe.

Hello Alex.

In preparing for the hearing today, the tenant reached out alerting me to <u>minor</u> Operational inconstancies pertaining to some durations in Condition 1 of the Minor IUP that they need to adjust so it complies with their legal documents. I did alert them to the ZA sentence that allows revisions, but they want it adjusted in the condition language. While minor, apparently it is very critical to them.

Would you kindly read in the adjustments at the ZA hearing so the condition is adjusted pursuant to the attached world file language?

Thank you.

tarek shaer principal

urbanestgroup t. 310 508 7354 tarek@urbaNestgroup.com



Please consider the environment before printing this page

Confidentiality: This email and any attached files contain confidential information belonging to Urbanest Group Inc. which is legally privileged. The information is intended only for the use of the person to whom this email is addressed. If you are not the intended recipient, you are hereby notified that any disclosure, copying, distribution or the taking of any action in reliance on the contents of this email is strictly prohibited. If you believe you are not the intended recipient, please immediately notify us by reply email or telephone at 310-508-7354.

- 1. This approval is to allow for the operation of a parcel delivery service with accessory office and customer service area (e.g. package pick-up and return) located at 15272 Bear Valley Road. Facility hours of operation are 24 hours a day seven days a week with general functions as follows:
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- Customer Service Operations (In person) 10AM-9PM daily.

The Zoning Administrator may allow revised hours of operation and accessory or revised services not listed in this approval, providing the primary use does not change and the changes do not negatively affect the public health, safety, and welfare nor cause nonconformance with the City Council Policy for Interim Uses (CP-11-05).

PUBLIC HEARINGS

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SUBJECT: PUBLIC COMMENTS ON PLANNING MATTERS

In compliance with the Brown Act, it is necessary for the Zoning Administrator to make available time for members of the public to address the Zoning Administrator on items of interest that fall within the Zoning Administrator's subject matter jurisdiction.

SW:cj